
The Enclosed Document Is Provided For Your Convenience.


Please Email ALL Questions:

MailTo:ContractAdministration@TampaGov.net

Please Let Us Know If You Plan To Bid

City of Tampa
Contract Administration Department
306 E. Jackson St. #280A4N
Tampa, FL 33602
(813)274-8456

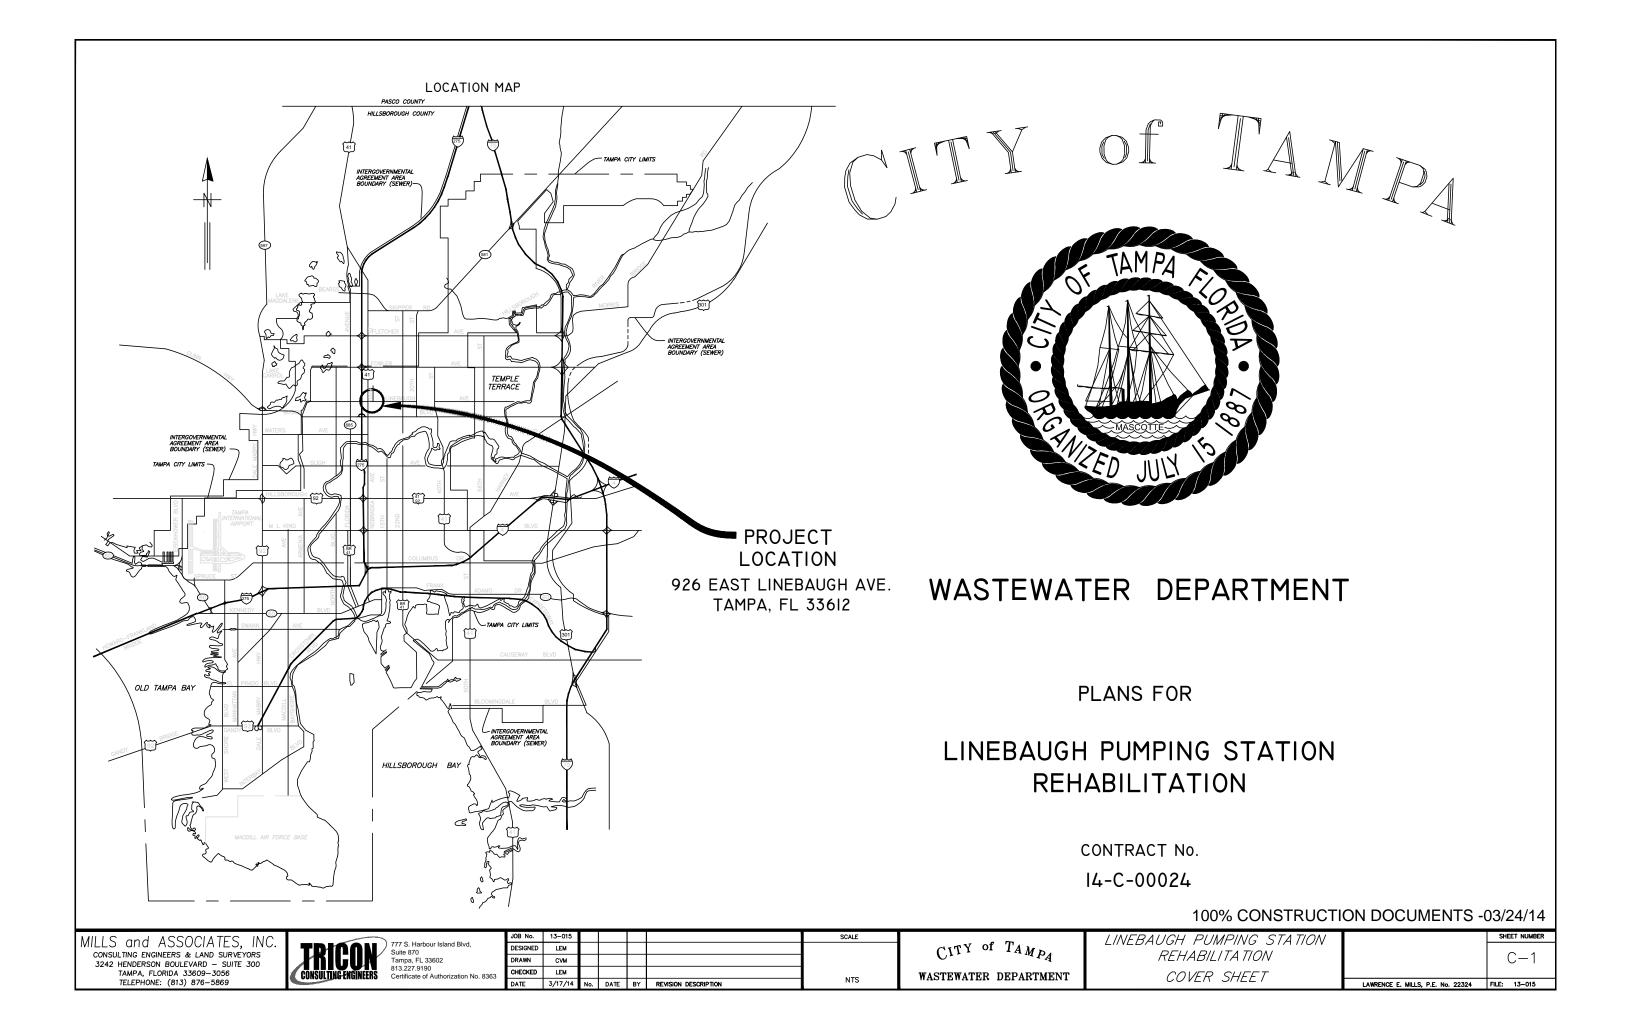

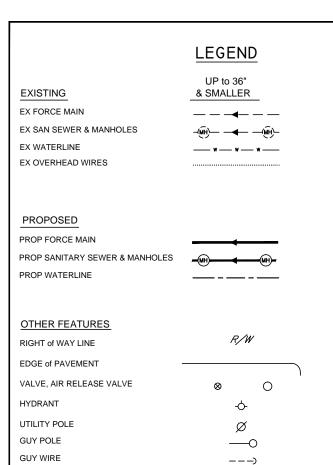


V

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E

T

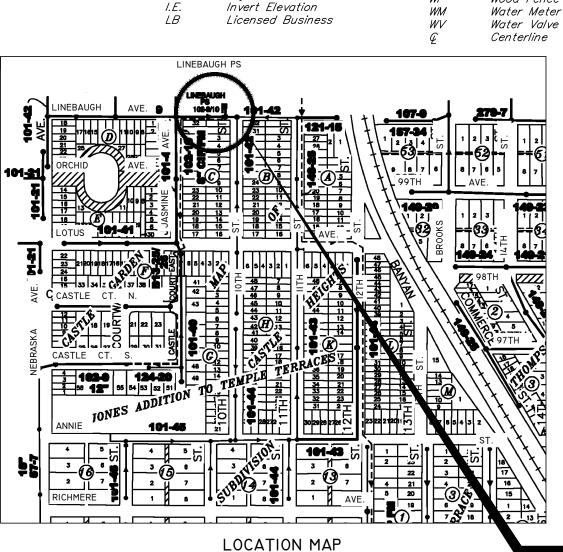

ABBREVIATIONS

Concrete

Cast Iron

Cast Iron Pipe

Electric Box

Fire Hydrant

Force Main

Guy Wire

Found Iron Pipe

Existing

Electric Meter

Chain Link Fence

Ductile Iron Pipe

Edge of Pavement

Found Parker Kalon Nail & Disk

Backflow Preventer

MH

NCF

PS

PVC

(R)

R/W

ŔMJ

SSMH

OHW

T.O.P.

TR

WF

PROP.

Manhole

Plat data

Proposed

Reported

Pump Station

Right of Way

Overhead Wires

Top of Pipe

Utility Pole

Wood Fence

Polyvinyl Chloride Pipe

Sanitary Sewer Manhole

Transformer on Conc.

Restrained Mechanical Joint

No corner found

BFP

Conc.

CI

CIP

CLF

DIP

EΒ

ЕМ

FH

FIP

FΜ

GW

FPK&D

EOP

Exist.

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GEOMETRIC LAYOUT AND GRADING PLAN PROPOSED LANDSCAPE & FENCE PLAN WET WELL TOP SLAB PLAN / SECTION B-B VIEW VALVE MANIFOLD SLAB SECTION J-J PIPE SUPPORT AND HOOK RACK DETAILS DEMOLITION PLAN VIEWS ENTRANCE / INTERMEDIATE / FOUNDATION FLOOR PLAN

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LEGAL DESCRIPTION: (for reference only)

Lots 19 through 23, Map of Castle Heights, as per map or plat thereof as recorded in Plat Book 10, Page 32 of the Public Records of Hillsborough County, Flroria.

LINEBAUGH PS PROJECT LOCATION 926 EAST LINEBAUGH AVE. TAMPA, FL 33612

100% CONSTRUCTION DOCUMENTS -03/24/14

MILLS and ASSOCIATES, INC CONSULTING ENGINEERS & LAND SURVEYORS 3242 HENDERSON BOULEVARD - SUITE 300 TAMPA, FLORIDA 33609-3056

VALVE VAULT

WATER METER

CRAPE MYRTLE

FENCE

HEDGE

SIGN

ELECTRICAL MANHOLE or VAULT

TELEPHONE MANHOLE or VAULT



777 S. Harbour Island Blvd, Suite 870 Tampa, FL 33602 813.227.9190 Certificate of Authorization No. 8363

	JOB No.	13-015					SCALE	Γ
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N.T.S.

CITY of TAMPA WASTEWATER DEPARTMENT LINEBAUGH PUMPING STATION REHABILITATION LOCATION MAP & INDEX

SHEET NUMBER C-2LAWRENCE E. MILLS, P.E. No. 22324 FILE: 13-015

DEMOLITION NOTES

- D-1. SALVAGEABLE MATERIAL, AS DETERMINED BY DEPARTMENT PERSONNEL, SHALL BE DELIVERED TO THE PARTS WAREHOUSE LOCATED ON THE TREATMENT PLANT SITE. NON-SALVAGEABLE MATERIALS ARE TO BE REMOVED FROM THE SITE AND PROPERLY DISPOSED OF AT THE CONTRACTOR'S EXPENSE.
- D-2. THE CONSTRUCTION SITE SHALL BE MAINTAINED IN AS NEAT AND ORDERLY CONDITION AS POSSIBLE DURING CONSTRUCTION OPERATIONS.

 SITE SHALL BE SECURED WITH TEMPORARY FENCING AND STRUCTURES DURING HOURS WHEN CONTRACTOR IS NOT PRESENT TO ENSURE SAFETY OF CITY EMPLOYEES AND THE PUBLIC.
- D-3. CONTRACTOR SHALL RESTORE ALL LANDSCAPING, SODDING, SPRINKLER SYSTEM PIPING AND PAVEMENT THAT MAY HAVE BEEN DAMAGED DURING CONSTRUCTION TO ITS ORIGINAL CONDITION OR BETTER. CONTRACTOR SHALL SOD ALL UNPAVED AREAS.

GENERAL NOTES

- G-1. CONTRACTOR SHALL COORDINATE ALL CONSTRUCTION ACTIVITIES WITH THE CONTRACT ADMINISTRATION DEPARTMENT, WASTEWATER PERSONNEL AND PUMPING STATION OPERATIONS.
- G-2. CONTRACTOR IS RESPONSIBLE FOR OBTAINING ALL NECESSARY RIGHT-OF-WAY PERMITS FOR THE PUMPING STATION WORK.
- G-3. THE CITY WILL OBTAIN ALL NECESSARY BUILDING PERMITS AND FDEP WASTEWATER PERMITS.
- G-4. CONTRACTOR SHALL CALL SUNSHINE (1-800-432-4770) AT LEAST 48 HOURS PRIOR TO ANY CONSTRUCTION ACTIVITY.
- G-5. NORMAL WORKING HOURS SHALL BE WEEKDAYS FROM 7:30 AM TO 4:00 PM UNLESS OTHERWISE APPROVED BY THE ENGINEER.
- G-6. PROPOSED PUMPS ARE (2) FLYGT PUMPS, MODEL 3127.185. 10HP PUMPS SHALL BE SUPPLIED WITH FLYGT MIX-FLUSH VALVES. ALL PROPOSED PUMP BASES SHALL BE 6-INCH DIAMETER DISCHARGE ELBOWS. IMPELLER DIAMETER 202 mm.
- G-7. REMOVAL OF EXISTING PAVEMENT AND BASE MATERIAL SIDEWALK, CURB, POLES, UNDERGROUND PIPES, STRUCTURES, FOUNDATIONS, AND OTHER MISCELLANEOUS ITEMS SHALL BE INCLUDED IN THE LUMP SUM PRICE AND NO SEPARATE PAYMENT WILL BE MADE.
- G-8. CONTRACTOR SHALL VERIFY QUANTITIES OF ALL NECESSARY PIPES, REDUCERS, FITTINGS, SUPPORTS, AND ANY MISCELLANEOUS BRACKETS.
- G-9. DIMENSIONS SHOWN ARE NOT NECESSARILY ACCURATE TO THE DEGREE REQUIRED FOR FABRICATION. EXISTING DIMENSIONS AND VIEWS
 ARE SHOWN BASED ON THE BEST INFORMATION AVAILABLE. CONTRACTOR SHALL FIELD VERIFY ALL PERTINENT DIMENSIONS AND REFLECT
 THEM ON DETAILED SHOP DRAWINGS FOR APPROVAL BEFORE ANY FABRICATION.
- G-10. SHOP DRAWINGS SHALL BE SUBMITTED AND APPROVED BY THE CITY FOR ALL PROPOSED ITEMS. ALL SUBMITTALS AND SHOP DRAWINGS SHALL BE ORIGINALS OR HIGH QUALITY COPIES (CLEARLY LEGIBLE). NO FAXED SHEETS OR POOR QUALITY COPIES WILL BE ACCEPTED FOR SUBMITTAL REVIEW.
- G-11. PUMP DISCHARGE PIPING IN WET WELL SHALL BE 6-INCH DIAMETER HDPE (PE4710), SDR-11, GREEN STRIPE, DIPS-OD. HDPE JOINTS SHALL BE FLANGED WITH 316 SS BACK UP RINGS. HDPE ELECTROFUSION JOINTS WILL BE ALLOWED, BUT ONLY IN THE WET WELL WITHIN 5 FEET FROM THE BOTTOM OF THE TOP SLAB.
- G-12. PLUG VALVES SHALL BE DEZURIK, PEF 100% PORT, ECCENTRIC PLUG VALVES OR APPROVED EQUAL. ALL ABOVE GROUND PLUG VALVES SHALL BE PROVIDED WITH 2" NUTS AND NO HANDWHEELS.
- G-13. CHECK VALVES SHALL BE APCO RUBBER FLAPPER SWING CHECK VALVES, SERIES 100. THIS EQUIPMENT IS A STANDARDIZED ITEM AT THIS FACILITY AND NO "OR EQUAL" SUBMITTALS WILL BE CONSIDERED.
- G-14. ALL HARDWARE, UNLESS OTHERWISE NOTED, SHALL BE TYPE 316 STAINLESS STEEL.
- G-15. PIPE SUPPORTS SHALL BE CONSTRUCTED AS SHOWN IN THE PIPE SUPPORT DETAIL
- G-16. ALL CEMENTITIOUS CONCRETE AND GROUT, UNLESS OTHERWISE NOTED, SHALL BE CLASS "B", 4000 PSI COMPRESSIVE STRENGTH AT 28 DAYS. ALL REINFORCING STEEL SHALL BE GRADE 60.
- G-17. OSHA STANDARD SAFETY EQUIPMENT SUCH AS SAFETY HARNESSES, GAS MONITORS, LOWER EXPLOSIVE LIMIT (LEL) DETECTORS, BREATHING APPARATUS, ETC. SHALL BE UTILIZED WHERE THE WORK DICTATES THEIR USE.
- G-18. ALL METAL PIPE, FITTINGS, VALVES, ETC. SHALL RECIEVE:
 - 1) SHOP COAT ONE COAT, 4-6 MILS (DRY) TNEMEC N140-1211 EPOXY PRIMER.
 - 2) FIELD COAT ONE COAT, 5-7 MILS (DRY) TNEMEC SERIES 446 PERMA-SHIELD MCU
 - 3) FIELD COAT
 - A) ABOVE GRADE : ONE COAT, 4-6 MILS (DRY) TNEMEC 1074U ENDURASHIELD (WITH FACTORY ADDED UV BLOCKER)
 - B) BELOW GRADE : ONE COAT, 5-7 MILS (DRY) TNEMEC SERIES 446 PERMA-SHIELD MCU
- G-19. BACKFILL (NO CLAY OR CLAYEY MATERIAL) SHALL BE COMPACTED IN 6-INCH LAYERS (MAX.) TO 98% MAXIMUM DRY DENSITY OF MODIFIED PROCTOR IN CONFORMANCE WITH AASHTO T-180, METHOD A.

- G-20. ALL STAINLESS STEEL PARTS TO BE WELDED SHALL BE THE LOW-CARBON VERSION OF THE GRADE OF STAINLESS STEEL THAT IS CALLED FOR, SUCH AS: T-316L OR T-304L.
- G-21. CONTRACTOR SHALL PROVIDE A REDUCED PRESSURE BACKFLOW-PREVENTION DEVICE IN WATER SERVICE LINE, AS SHOWN IN DETAILS, AT A PLACE TO BE SPECIFIED DURING CONSTRUCTION. BACKFLOW PREVENTION DEVICE SHALL BE 1" WILKINS, MODEL #975 XL. OR EQUAL.
- G-22. ALUMINUM ACCESS COVERS SHALL BE DESIGNED FOR A PEDESTRIAN LIVE LOADING OF 300 PSF WITH 316 STAINLESS STEEL HARDWARE, HINGES AND AUTOMATIC HOLD-OPEN ARM AS MANUFACTURED BY US FOUNDRY AND MANUFACTURING CORPORATION OR APPROVED EQUAL. THE ACCESS DOORS SHALL ALSO BE EQUIPPED WITH A FLUSH LIFTING HANDLE, TAMPERPROOF FASTENERS AND EXPOSED PADLOCK STAPLES.
- G-23. THE ACCESS COVER SHALL CLOSE FLUSH WITH THE FRAME. ALL ALUMINUM SURFACES THAT CONTACT CONCRETE SHALL BE COATED WITH TWO COATS OF COAL TAR EPOXY OR BITUMINOUS COATING OR EQUAL. THE CONTRACTOR SHALL SUBMIT SHOP DRAWINGS DETAILING THE INSTALLATION AND CONFIGURATION OF THE ACCESS COVERS.
- G-24. PROPOSED PRECAST WET WELL SHALL BE CONSTRUCTED IN ACCORDANCE WITH ASTM C-76, CLASS II WALL B. MINIMUM STEEL REINFORCEMENT SHALL BE INNER CAGE .76 IN^2/FT AND OUTER CAGE .46 IN^2/FT. (SEE SPECIFICATIONS)
- G-25. ALL DIP PIPE AND FITTING SHALL BE CLASS 53 WITH PROTECTO 401 INTERIOR COATING.
- G-26. PVC GRAVITY PIPE AND FITTINGS SHALL BE SDR-26 (HEAVY WALL) IN COMPLIANCE TO ASTM D3034. PVC FM PIPE AND FITTINGS SHALL BE C-900 (DR-18)
- G-27. ALL CONCRETE PAVEMENT, UNLESS OTHERWISE NOTED, SHALL BE MINIMUM 6" THICK CONCRETE WITH 4x4 W6xW6 WWF.

 CONCRETE SHALL BE CONSTRUCTED ON COMPACTED SUB-BASE (MINIMUM 98% MODIFIED PROCTOR)

 WITH 1.5" DEEP CONTROL JOINTS SAW-CUT @ 15' MAX. CUT WITHIN 12 HRS OF CONCRETE PLACEMENT.
- G-28. CONTRACTOR TO SUBMIT METHOD FOR 100% WATERTIGHT SEALING AT PIPE PENETRATIONS THROUGH STRUCTURES, PROPOSED LINK SEAL OR APPROVED EQUAL.
- G-29. THE CITY DOES NOT BELIEVE THAT ASBESTOS IS PRESENT IN THE BUILDING. PER EPC REQUIREMENTS, CONTRACTOR WILL BE REQUIRED TO PROCURE A THIRD PARTY ASBESTOS SURVEY FROM A LICENSED ASBESTOS CONSULTANT. DEMOLITION OF PUMP STATION BUILDING CANNOT BEGIN UNTIL (3) WEEKS AFTER THE ASBESTOS SURVEY IS SUBMITTED TO THE ENGINEER. THE CITY WILL FURNISH EPC WITH THE REQUIRED NOTIFICATION. IF THE SURVEY DISCOVERS THE PRESENCE OF ASBESTOS, THE CITY WILL UTILIZE CONTINGENCY FUNDS FOR THE ASBESTOS REMOVAL IN ACCORDANCE WITH EPC STANDARDS.
- G-30. ELEVATION INFORMATION SHOWN ON THESE PLANS IS REFERENCED TO NGVD 1929 UNLESS OTHERWISE STATED.
- G-31. DURING CONSTRUCTION, CONTRACTOR SHALL MAINTAIN A CLEAR PATH TO EXISTING PUMPING STATION FOR CITY STAFFS TO ACCESS AND MAINTAINING THE EXISTING PUMPING STATION.
- G-32. CONTRACTOR SHALL PROTECT ALL TREES IN THE VICINITY OF THE PROPOSED CONSTRUCTION IN ACCORDANCE WITH CHAPTER 13
 OF THE CITY OF TAMPA CODE. NO TREES SHALL BE PRUNED WITHOUT PRIOR APPROVAL FROM THE CITY OF TAMPA PARKS
 AND RECREATION DEPARTMENT, NATURAL RESOURCES DIVISION, AND SHALL BE COMPLETED BY A CERTIFIED ARBORIST. ROOT
 PRUNING MAY BE REQUIRED AT CERTAIN LOCATIONS AND COMPLETED IN ACCORDANCE WITH CHAPTER 13 TECHNICAL
 MANUAL SPECIFICATIONS.
- G-33. THE CONTRACTOR SHALL PERFORM AN INFILTRATION/EXFILTRATION TEST ON ALL GRAVITY SEWERS AND A PRESSURE TEST ON ALL FORCE MAINS (AS APPLICABLE) IN ACCORDANCE TO THE CITY OF TAMPA'S WASTEWATER DEPARTMENT REGULATIONS. SAID TEST ARE TO BE CERTIFIED BY THE ENGINEER OF RECORD AND SUBMITTED TO THE CITY OF TAMPA WASTEWATER DEPARTMENT FOR APPROVAL. THE SCHEDULING, COORDINATION AND NOTIFICATION TO ALL PARTIES IS THE CONTRACTOR'S RESPONSIBILITY.
- G-34. REFER TO SUBSURFACE INVESTIGATION REPORT DATED NOV. 19, 2013 BY BTL ENGINEERING SERVICES, INC. FOR PROJECT AREA GEOTECHNICAL INFORMATION.

BYPASSING NOTES

- B-1. SEWER SERVICE TO CUSTOMERS SHALL NOT BE DISRUPTED DURING CONSTRUCTION. CONTRACTOR SHALL SUBMIT DETAILED PROPOSAL FOR PUMPING STRATEGY.
- B-2. IT IS THE ENGINEER'S INTENT THAT THE NEW PUMPING STATION WILL BE CONSTRUCTED WHILE THE EXISTING PUMPING STATION REMAINS IN OPERATION. DURING THE START-UP OF THE NEW PUMP STATION, THE EX. PUMP STATION MUST BE CAPABLE OF OPERATING IN THE EVENT THERE ARE PROBLEMS WITH THE NEW PUMP STATION. AS AN ALTERNATIVE OF KEEPING THE OLD PUMP STATION OPERATIONAL, THE CONTRACTOR MAY PROVIDE BYPASS PUMPING RATED FOR 600 GPM @ 38' TDH.

100% CONSTRUCTION DOCUMENTS -03/24/14

MILLS and ASSOCIATES, INC. consulting engineers & land surveyors 3242 henderson boulevard – suite 300 tampa, florida 33609–3056



777 S. Harbour Island Blvd, Suite 870 Tampa, FL 33602 813.227.9190 Certificate of Authorization No. 8363

JOB No.	13-015					SCALE
DESIGNED	LEM					
DRAWN	CVM					
CHECKED	LEM					
DATE	3/17/14	No.	DATE	BY	REVISION DESCRIPTION	NTS

 C^{ITY} of $T_{AMP_{m{4}}}$ WASTEWATER DEPARTMENT

LINEBAUGH PUMPING STATION REHABILITATION GENERAL NOTES (1) SHEET NUMBER

C — 3

LAWRENCE E. MILLS. P.E. No. 22324 FILE: 13-015

STANDARD SITE PLAN NOTES:


- 1. All work shall comply with the regulations, requirements and ordinances of the various governing agencies having jurisdiction over said work, including, and not limited to: Hillsborough County EPC, City of Tampa, and F.D.E.P. and others as may be applicable.
- 2. The Contractor shall maintain copies of all applicable permits on—site and shall be responsible to adhere to all permit conditions during construction.
- 3. Location, dimension, elevation, and identification of existing utilities, structures and other topographic features are approximate only, according to the best information available at the time of preparation of these plans. There may be additional existing details on—site and off—site, the presence of which is not known or detected at this time. Engineer/Surveyor shall not be held responsible for undetected underground utilities. Prior to construction, it is the Contractor's responsibility to verify the location, dimension, elevation and identification of all utilities, structures and topographic features (i.e. buildings, sidewalks, canopy supports, fences, pavement, underground utilities, utility poles/guy wires, manholes, inlets, a/c units, trees, landscaping, etc.). If any of the existing or proposed conditions either: a) conflict with the proposed improvements, or b) are not shown or shown incorrectly on the plans, it is the Contractor's responsibility to contact the Engineer prior to the commencing any work activities.
- 4. The construction testing/inspection shall be the Contractor's responsibility to schedule and complete any and all tests as required with all site civil improvements constructed on and off site. It shall also be the Contractor's responsibility to pre-test these improvements prior to giving the Engineer-of-Record any governing agency field representative 48 hours advance notice of any formal tests.
- 5. Engineer/Surveyor shall not be held responsible for undetected underground utilities and/or soil conditions Site preparation to be in accordance with a geotechnical engineers recommendations and as a minimum standard must confrom with the following: a) Unsuitable material to be removed upon Engineers approval; b) Fill material to be clean with no organics, muck, clay, trash, etc.; c) Fill to be placed in 12" lifts and compacted to 98% modified proctor; d) 4:1 maximum slope unless noted otherwise
- 6. Florida Statute 553.851 (1979) requires a minimum of 2 days and maximum of 5 days notice before excavation. Effective December 1, 1993, a new telephone number, SUNSHINE STATE ONE CALL OF FLORIDA, 1–800–432–4770 must be called for underground utility location purposes before you dig.
- 7. Contractor to maintain positive stormwater drainage and flood control during construction.
- 8. The Contractor shall use appropriate measures to prevent erosion and transport of sediment to surface drains. The Contractor shall use hay bales and/or silt barriers to mitigate adverse impacts to existing surface water quality.
- 9. All pipe lengths are plus or minus and are measured from center of fittings and/or structures.
- 10. Upon completion of the work, all surfaces and facilities will be returned to a minimum standard of profile and condition as existed prior to commencement of work.
- 11. Mills & Associates, Inc. makes no representations or guarantees pertaining to easements, rights of way, set back lines, reservations, agreements and other similar matters.
- 12. Contractor to coordinate scheduling of existing site lighting demolition and proposed site lighting installation with Tampa Electric Company.
- 13. Contractor to temporarily support all existing adjacent utilities/structures during pipeline/excavation work. Contact local utility for temporary securing of power poles, as necessary. Alignment may vary due to field conditions, contact Engineer. Prior to backfill of pipe trench, contact Engineer.

100% CONSTRUCTION DOCUMENTS -03/24/14

MILLS and ASSOCIATES, INC. consulting engineers & land surveyors 3242 henderson boulevard - suite 300 tampa, florida 33609-3056 TELEPHONE: (813) 876-5869



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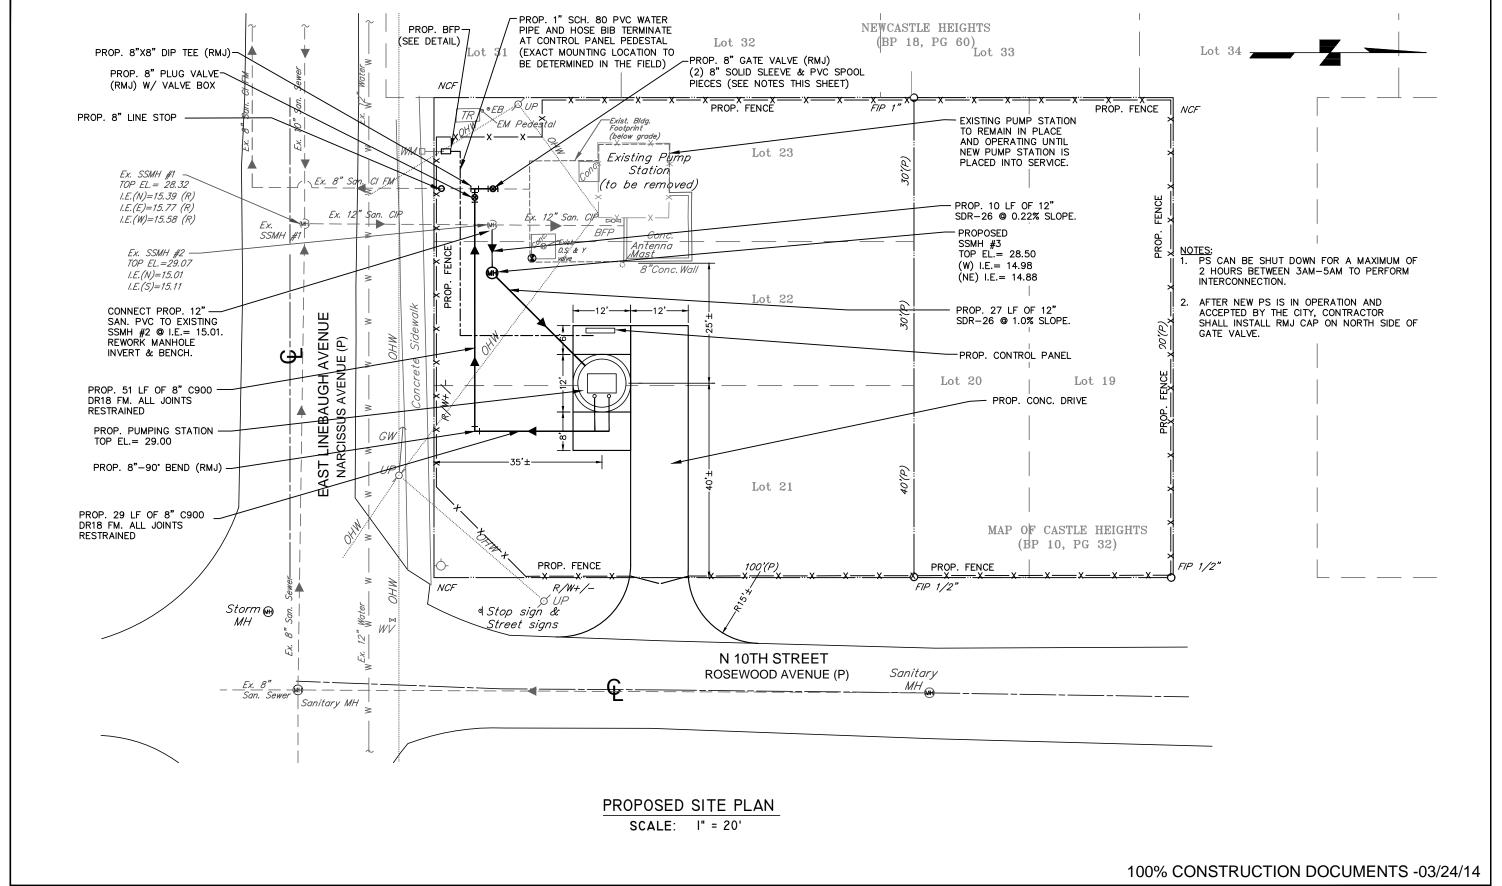
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 C^{1TY} of $T_{AMP_{\mathcal{A}}}$ wastewater department

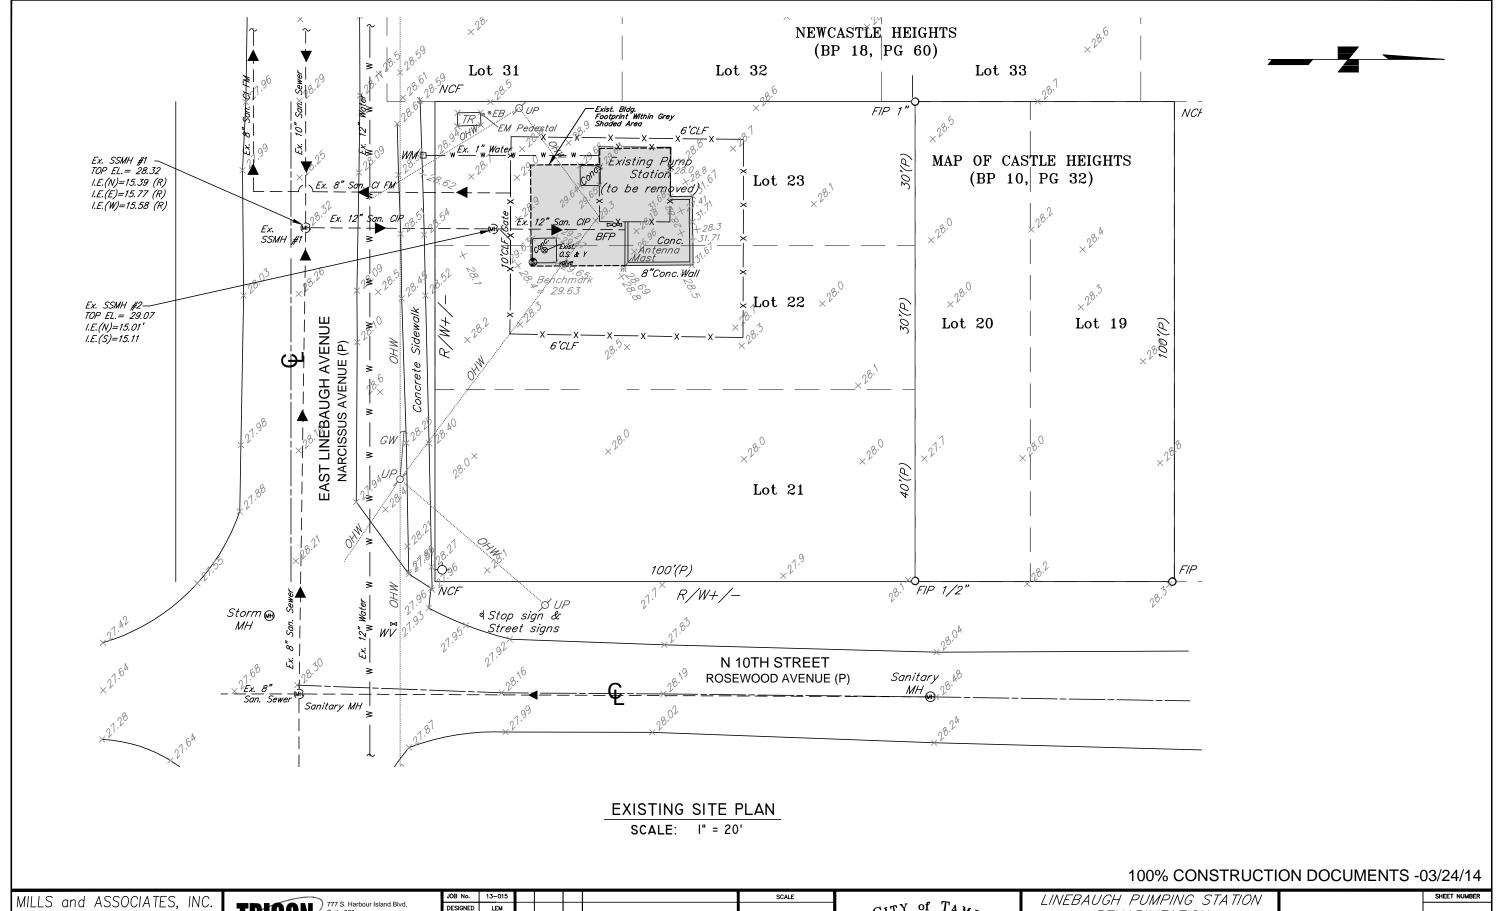NEBAUGH PUMPING STATION REHABILITATION EXISTING SITE PLAN

LAWRENCE E. MILLS, P.E. No. 22324 FILE: 13-015



MILLS and ASSOCIATES, INC.

CONSULTING ENGINEERS & LAND SURVEYORS

3242 HENDERSON BOULEVARD - SUITE 300

TAMPA, FLORIDA 33609-3056

TELEPHONE: (813), 876-5869

777 S. Harbour Island Blvd, Suite 870 Tampa, FL 33602 813,227,9190 Certificate of Authorization No. 8363
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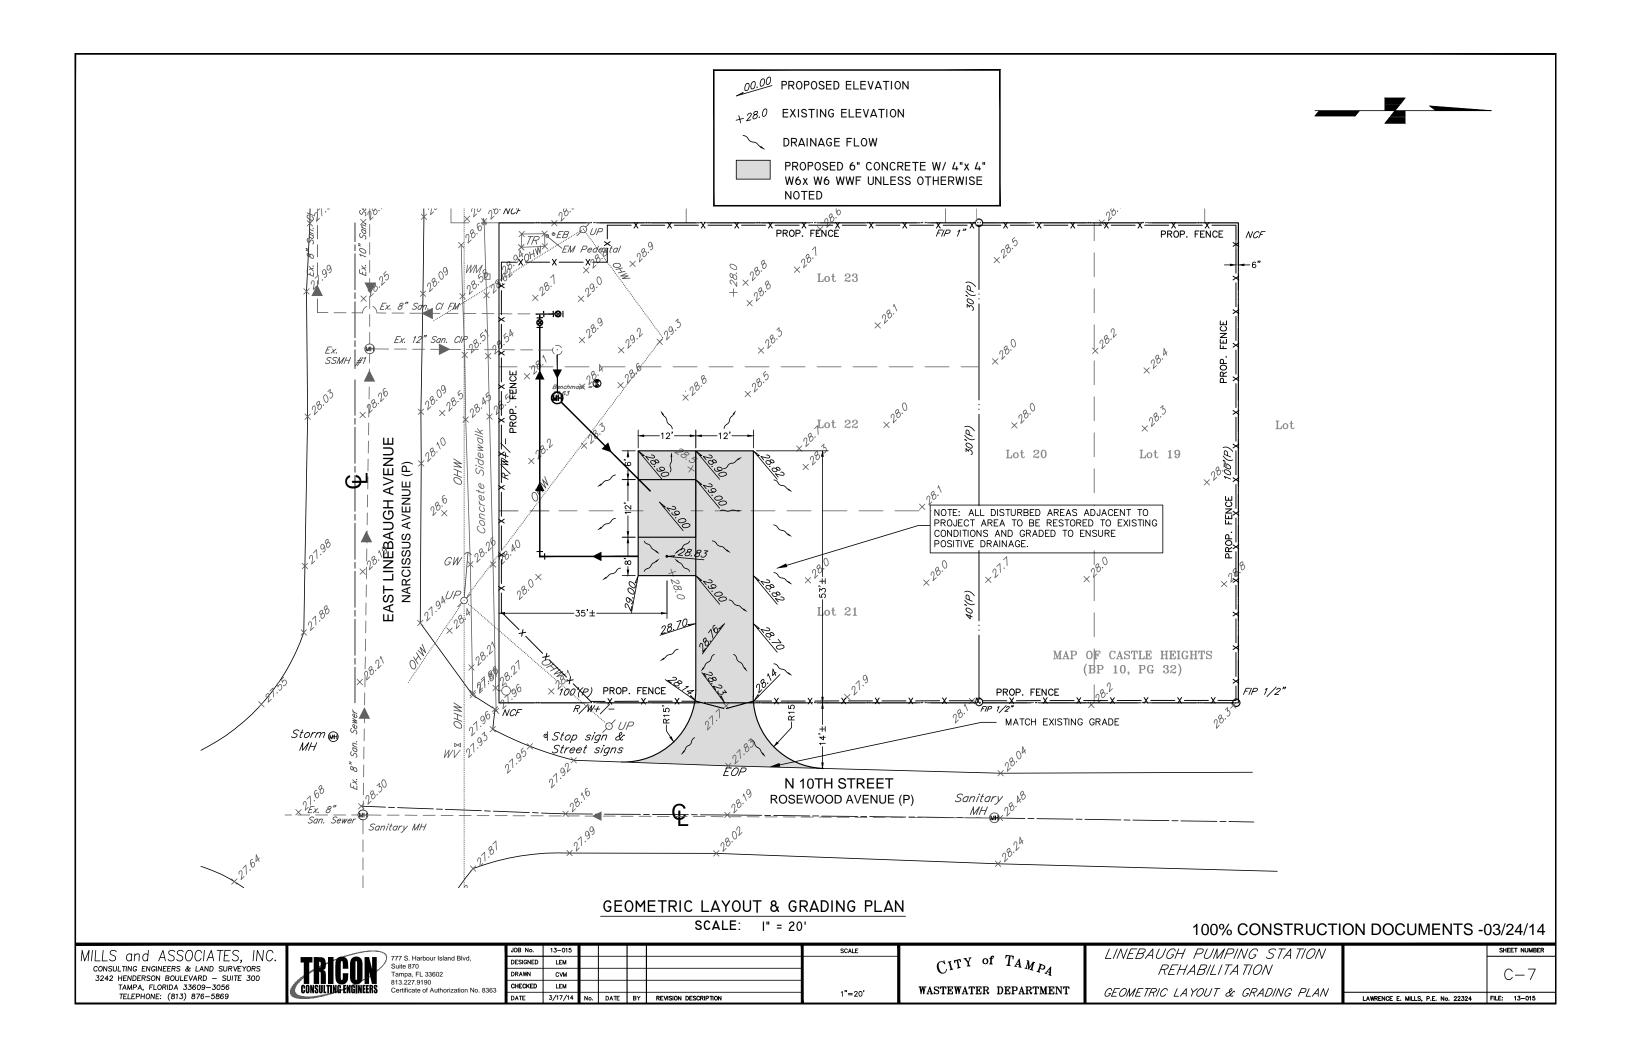
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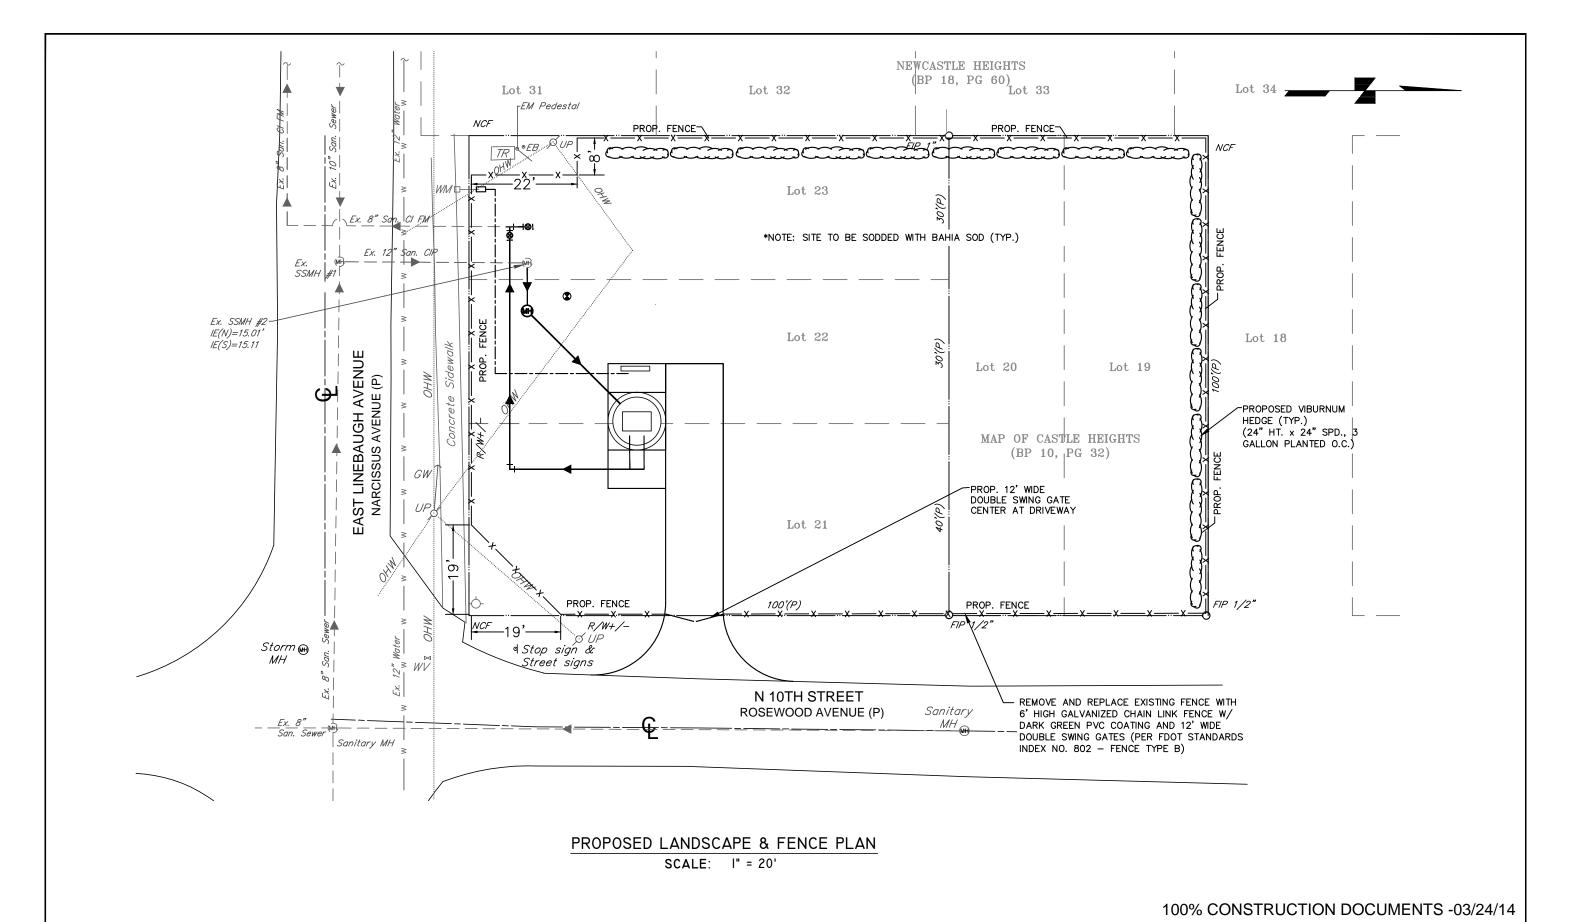
LINEBAUGH PUMPING STATION REHABILITATION PROPOSED SITE PLAN

SHEET NUMBER

C — 6

LAWRENCE E. MILLS, P.E. No. 22324 FILE: 13-015





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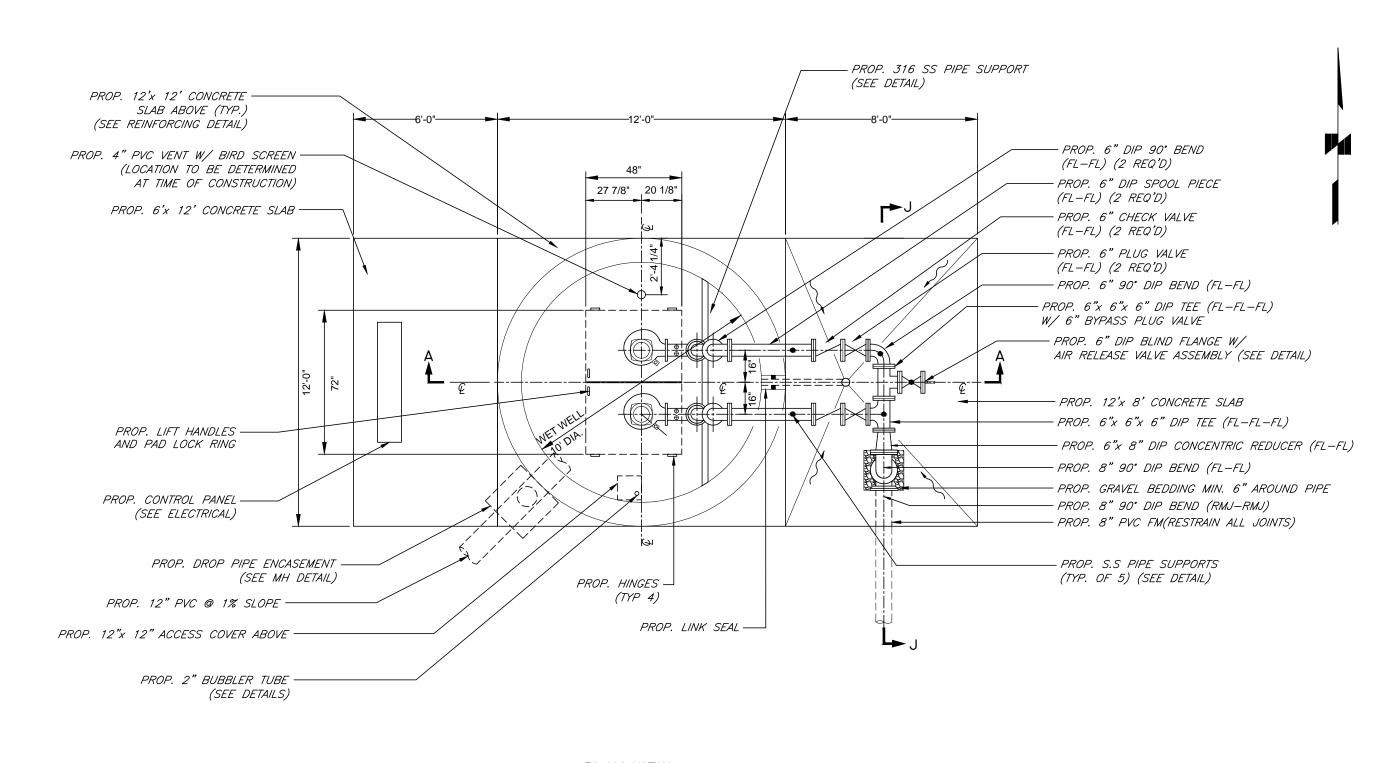
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 C^{1TY} of $T_{AMP_{ ilde{A}}}$ wastewater department

LINEBAUGH PUMPING STATION REHABILITATION PROPOSED LANDSCAPE & FENCE PLAN SHEET NUMBER

C — 8

LAWRENCE E. MILLS, P.E. No. 22324 FILE: 13-015



PLAN VIEW

SCALE: 1/4" = 1'-0"

100% CONSTRUCTION DOCUMENTS -03/24/14

MILLS and ASSOCIATES, INC.
CONSULTING ENGINEERS & LAND SURVEYORS
3242 HENDERSON BOULEVARD - SUITE 300
TAMPA, FLORIDA 33609-3056
TELEPHONE: (813) 876-5869




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WASTEWAT	ER I	DEPARTMENT

LINEBAUGH PUMPING STATION REHABILITATION		-
PLAN VIEW	ŀ	_

	SHEET NUMBER
	C-9
LAWRENCE E. MILLS, P.E. No. 22324	FILE: 13-015

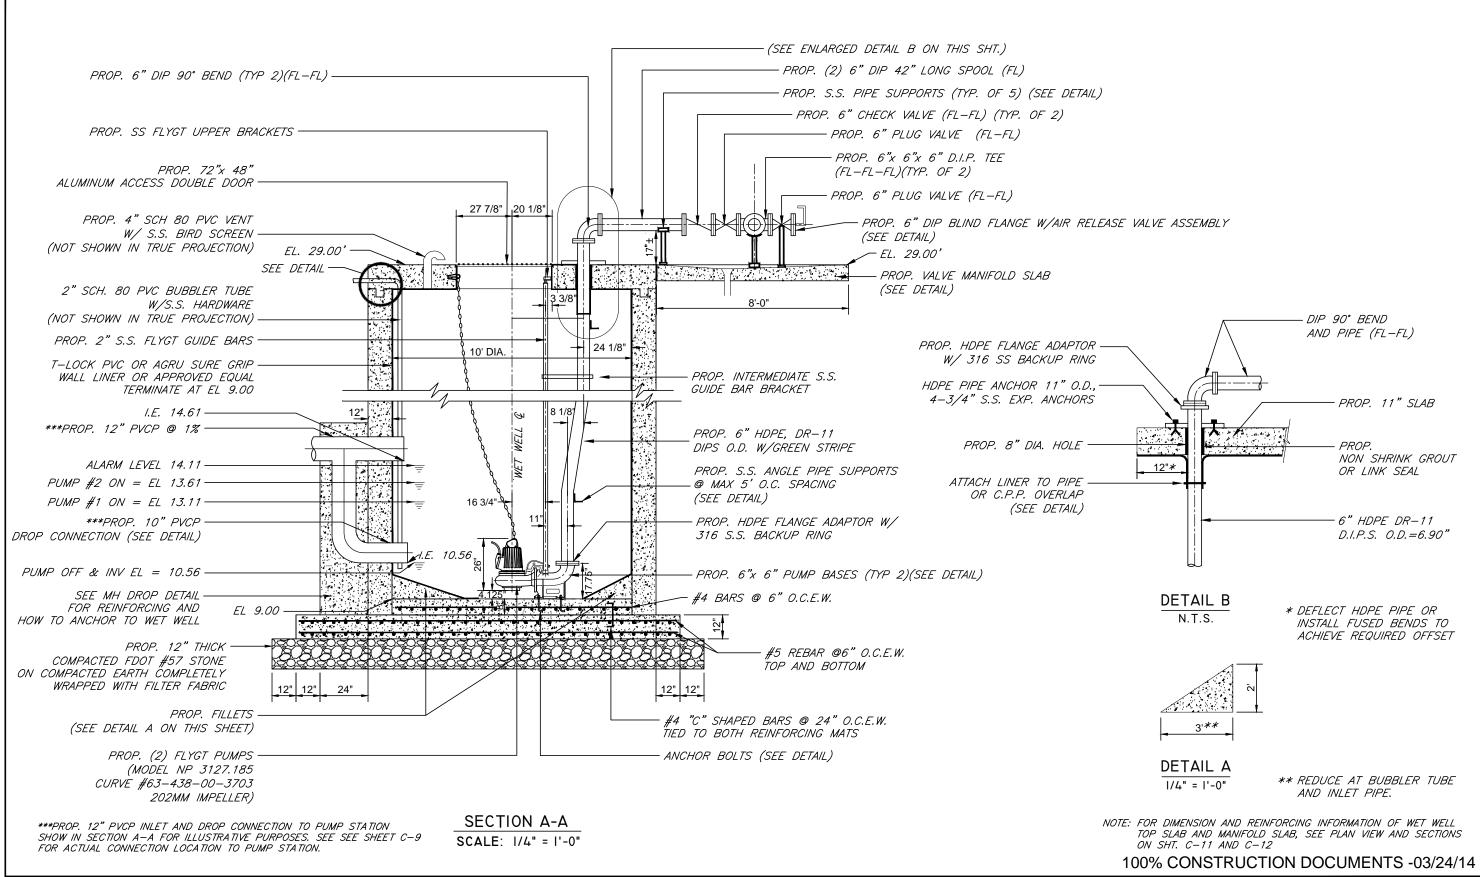

MILLS and ASSOCIATES, INC.

CONSULTING ENGINEERS & LAND SURVEYORS
3242 HENDERSON BOULEVARD - SUITE 300
TAMPA, FLORIDA 33609-3056
TELEPHONE: (813) 876-5869



 JOB No.
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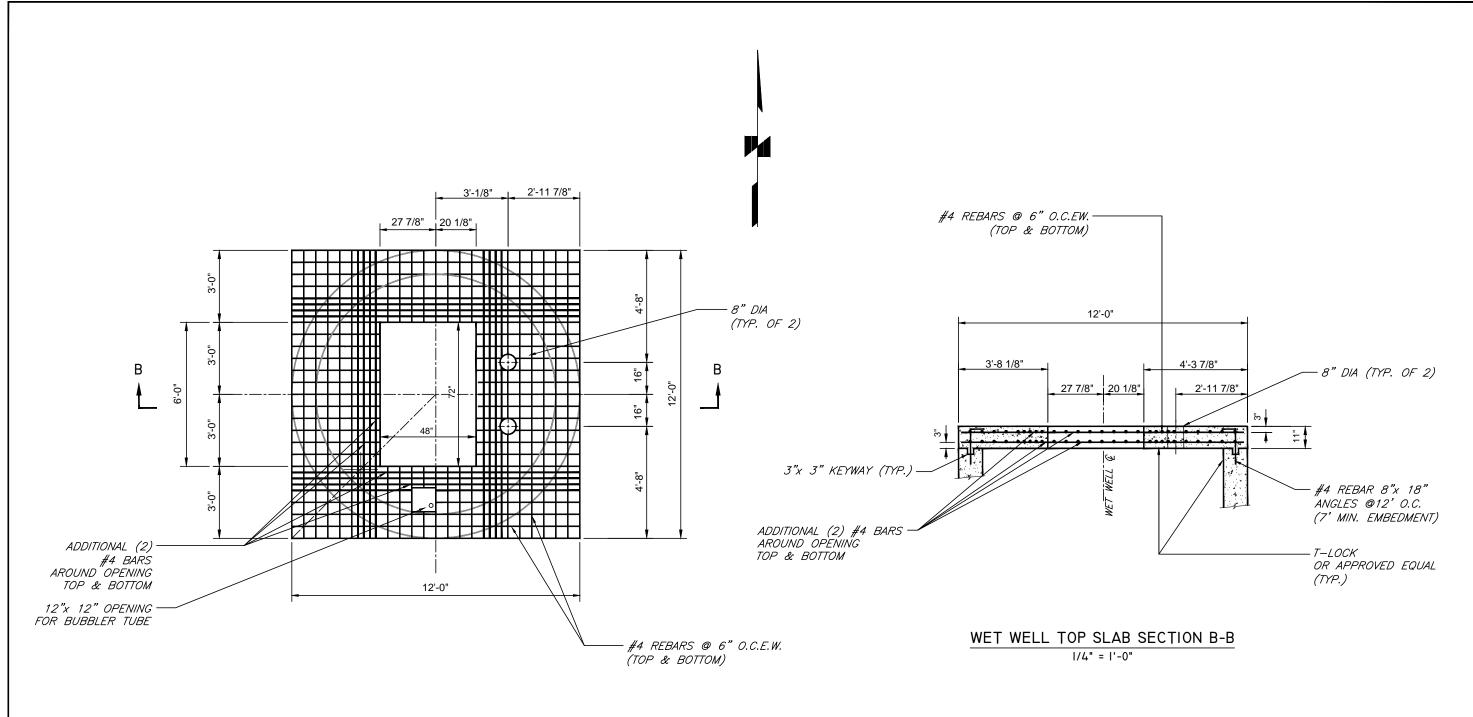
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 1/4"=1'-0"

 C^{1TY} of $T_{AMP_{\mathcal{A}}}$ wastewater department

LINEBAUGH PUMPING STATION REHABILITATION SECTION A-A/DETAILS SHEET NUMBER

C-10

LAWRENCE E. MILLS, P.E. No. 22324 FILE: 13-015



WET WELL TOP SLAB PLAN
1/4" = 1'-0"

100% CONSTRUCTION DOCUMENTS -03/24/14

MILLS and ASSOCIATES, INC.

CONSULTING ENGINEERS & LAND SURVEYORS
3242 HENDERSON BOULEVARD – SUITE 300
TAMPA, FLORIDA 33609–3056
TELEPHONE: (813) 876–5869




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DATE	3/17/14	No.	DATE	BY	REVISION DESCRIPTION	1/4"=1'-0"	

 C^{1TY} of $T_{AMP_{ extit{M}}}$ wastewater department

LINEBAUGH PUMPING STATION REHABILITATION WET WELL TOP SLAB PLAN/ SECTION B-B VIEW SHEET NUMBER

C-11

LAWRENCE E. MILLS, P.E. No. 22324 FILE: 13-015

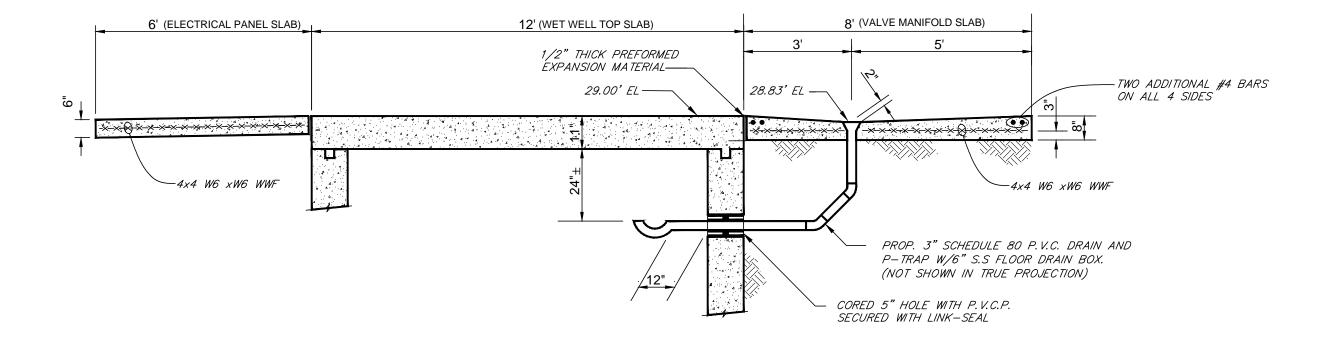

VALVE MANIFOLD SLAB SECTION 3/8" = 1'-0"

NOTE: THICKNESS OF ALL CONC. SLABS SHALL BE AS SHOWN AND NOT LESS THAN 6".

100% CONSTRUCTION DOCUMENTS -03/24/14

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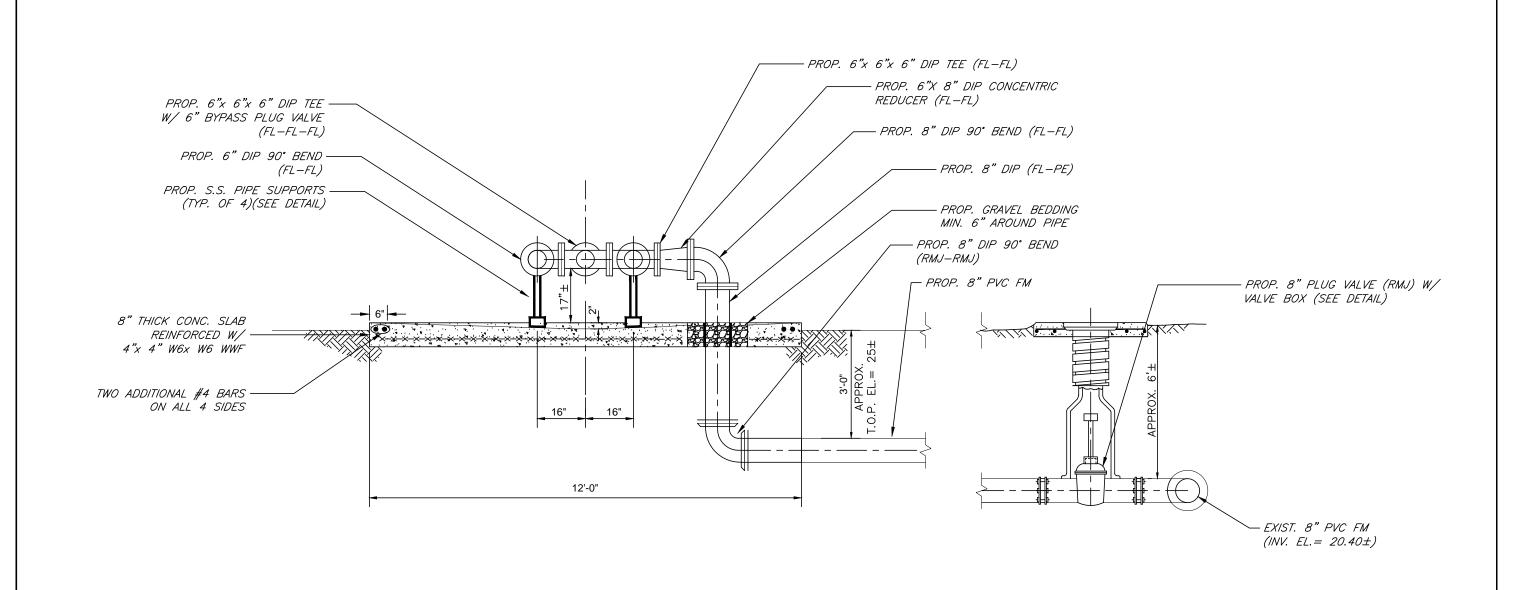
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3242 HENDERSON BOULEVARD - SUITE 300
TAMPA, FLORIDA 33609-3056
TELEPHONE: (813) 876-5869



JOB No.	13-015					SCALE
DESIGNED	LEM					
DRAWN	CVM					
CHECKED	LEM					7 /0" 1' 0"
DATE	3/17/14	No.	DATE	BY	REVISION DESCRIPTION	3/8"=1'-0"

 C^{1TY} of $T_{AMP_{\mathcal{A}}}$ wastewater department

LINEBAUGH PUMPING STATION REHABILITATION VALVE MANIFOLD SLAB SHEET NUMBER $\begin{array}{c} \text{SHEET NUMBER} \\ \\ \text{C-12} \\ \text{LAWRENCE E. MILLS, P.E. No. 22324} & \text{FILE: } 13-015 \end{array}$



VALVE MANIFOLD SLAB J-J 3/8" = 1'-0"

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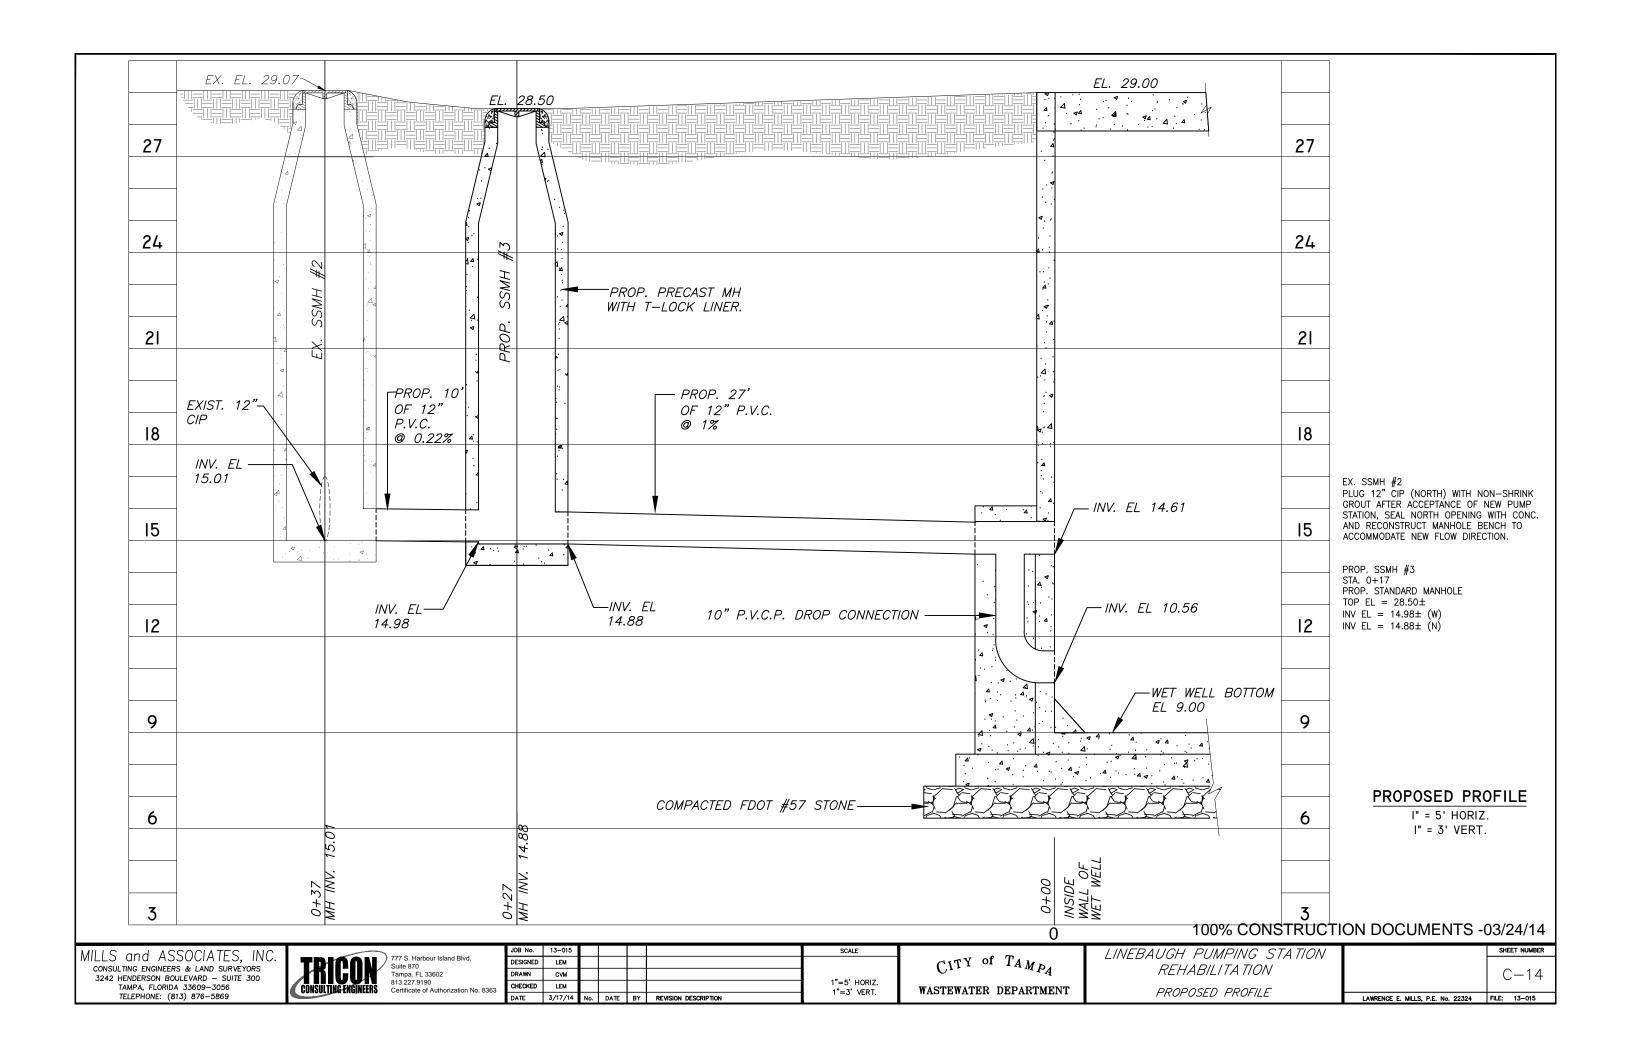
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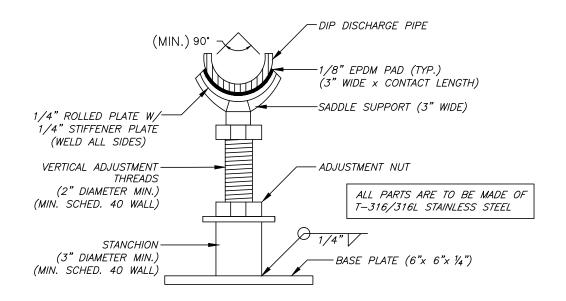


JOB No.	13-015					SCALE
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DATE	3/17/14	No.	DATE	BY	REVISION DESCRIPTION	3/0 =1 =0


 C^{1TY} of $T_{AMP_{\mathcal{A}}}$ wastewater department

LINEBAUGH PUMPING STATION REHABILITATION VALVE MANIFOLD SLAB SECTION J—J SHEET NUMBER $\begin{array}{c} \text{SHEET NUMBER} \\ \hline \\ \text{C}-13 \end{array}$ LAWRENCE E. MILLS, P.E. No. 22324 FILE: 13-015





SECTION VIEW - STAINLESS STEEL STANCHION SADDLE SUPPORT

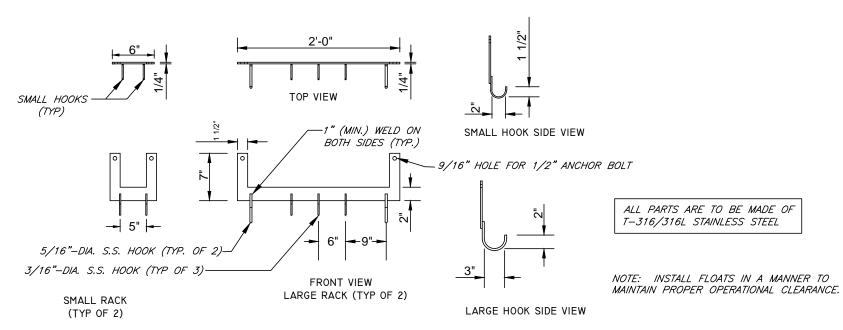

DETAIL "E" PROP. STAINLESS STEEL HOOK RACKS N.T.S.

100% CONSTRUCTION DOCUMENTS -03/24/14


MILLS and ASSOCIATES, INC. consulting engineers & land surveyors 3242 HENDERSON BOULEVARD - SUITE 300 TAMPA, FLORIDA 33609-3056 TELEPHONE: (813) 876-5869




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CHECKED	LEM					N.T.S.
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 ${\it CITY}$ of ${\it TAMP_A}$ wastewater department


LINEBAUGH PUMPING STATION REHABILITATION PIPE SUPPORT & HOOK RACK DETAILS SHEET NUMBER $\begin{array}{c} \text{SHEET NUMBER} \\ \hline \\ \text{C}-15 \\ \\ \text{LAWRENCE E. MILLS, P.E. No. 22324} & \text{FILE: } 13-015 \\ \end{array}$



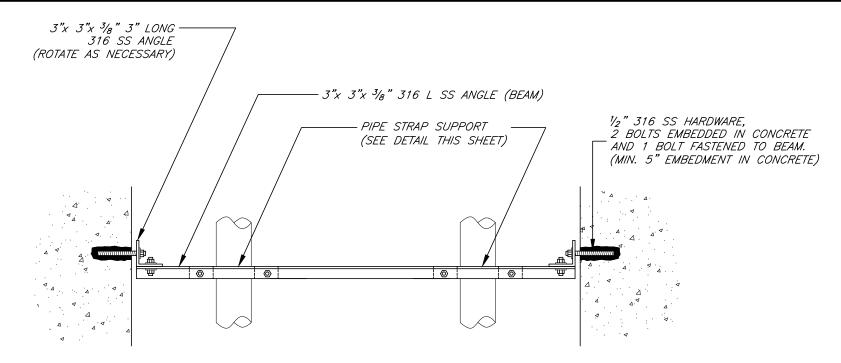

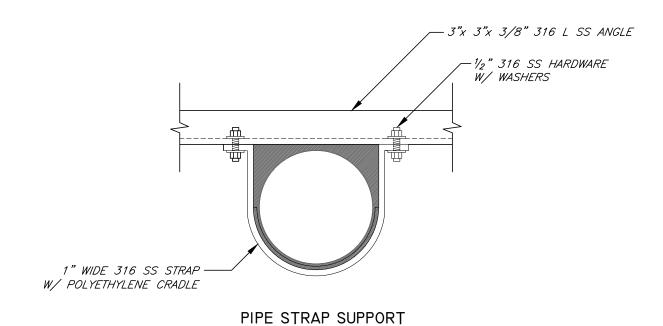

N.T.S.

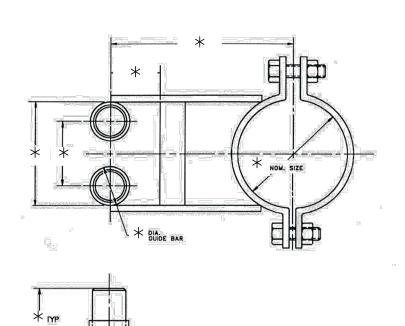



INTERMEDIATE GUIDE BAR BRACKETS
N.T.S.

* PER PUMP MANUFACTURER'S RECOMENDATION

100% CONSTRUCTION DOCUMENTS -03/24/14

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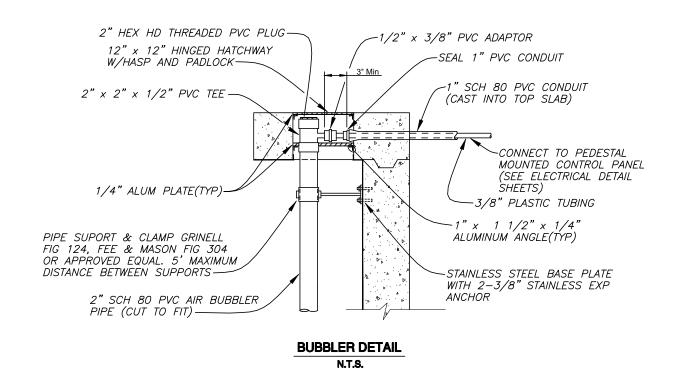



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 C^{1TY} of T_{AMP_A} WASTEWATER DEPARTMENT


LINEBAUGH PUMPING STATION
REHABILITATION
DETAILS (1)


SHEET NUMBER $\begin{array}{c} \text{SHEET NUMBER} \\ \hline \\ \text{C}-16 \\ \\ \text{LAWRENCE E. MILLS, P.E. No. 22324} & \text{FILE: } 13-015 \\ \end{array}$



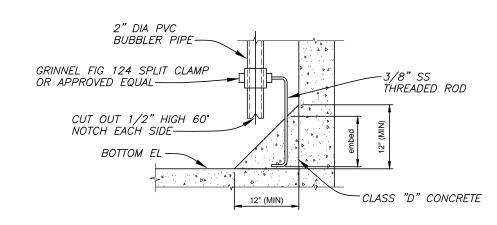


BUBBLER DETAIL N.T.S.

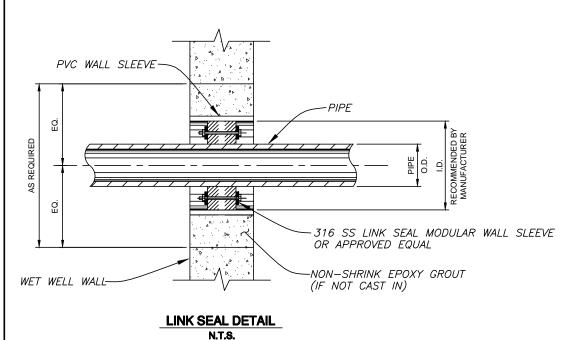

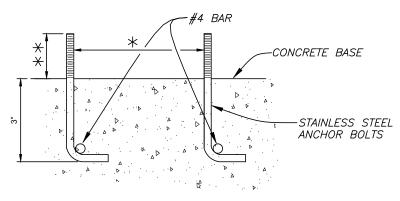

ALIGNMENT OF ANCHOR BOLTS SHALL BE AS RECOMMENDED BY PUMP MANUFACTURER.

** CONTRACTOR SHALL PROVIDE A MINIMUM 1/2 INCH BOLT PROTRUSION ABOVE THE FINAL NUT LOCATION AFTER THE NUT IS TIGHTENED TO MANUFACTURER'S RECOMMENDATION.

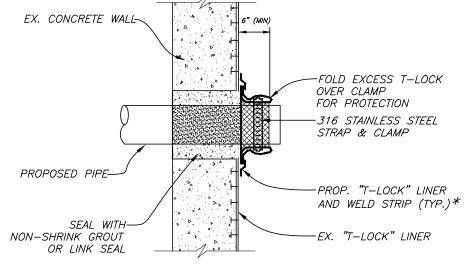

PIPE TO LINED STRUCTURE N.T.S.

ANCHOR BOLT DETAIL

*ALTERNATIVE: CONTRACTOR MAY COAT WITH 125 MILS C.P.P.
AND OVERLAP EXISTING T-LOCK BY 3".

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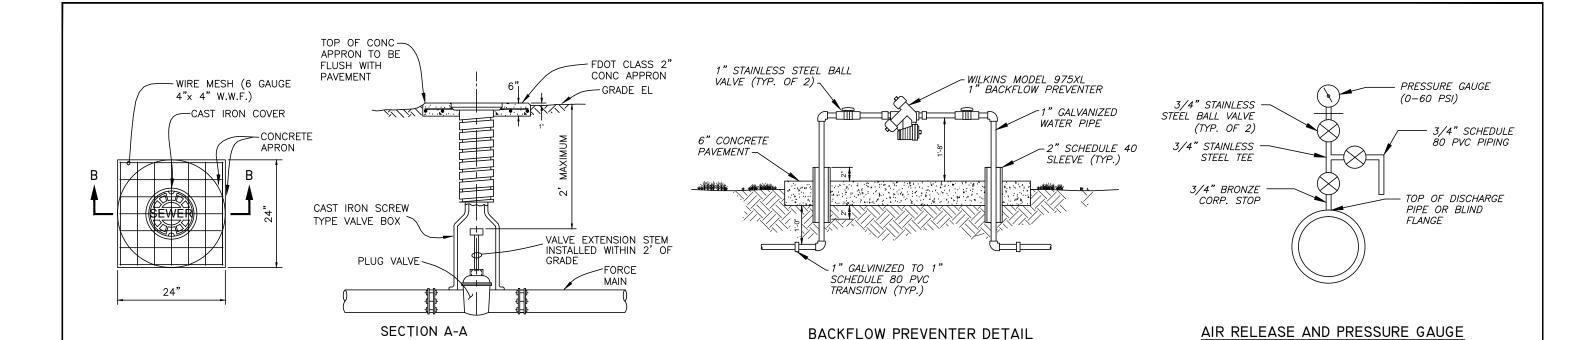


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CHECKED	LEM					N.T.S.
DATE	3/17/14	No.	DATE	BY	REVISION DESCRIPTION	

 C^{1TY} of $T_{AMP_{m{d}}}$ WASTEWATER DEPARTMENT

LINEBAUGH PUMPING STATION REHABILITATION DETAILS (2)


SHEET NUMBER -17 LAWRENCE E. MILLS, P.E. No. 22324 FILE: 13-015



VALVE BOX DETAIL

N.T.S.

* PER PUMP MANUFACTURER'S RECOMENDATION

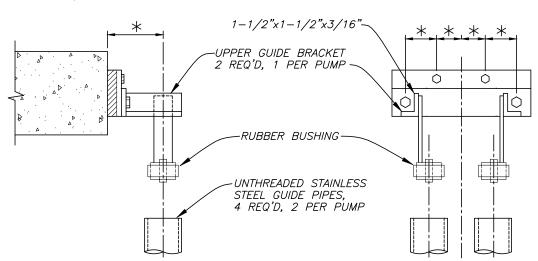

GUIDE BRACKET DETAIL (SUPPLIED WITH PUMPS)

CONC APPRON SURROUNDING BOX W/WIRE MESH (6 GAÚGE 4"x4" W.W.F.) COMPRESSION FITTING 211 Ш PLASTIC STAND BOX W/COVER _ ≨ Z 3/4" POLY-B COMPRESSION FITTING -3/4" CORPORATION STOP PLAN VIEW PROPOSED FORCE MAIN

AIR RELEASE VALVE DETAIL

N.T.S.

N.T.S.

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T	JOB No.	13-015					SCALE
	DESIGNED	LEM					
	DRAWN	CVM					
	CHECKED	LEM					N.T.S.
I	DATE	3/17/14	No.	DATE	BY	REVISION DESCRIPTION	14.1.3.

CITY of TAMPA WASTEWATER DEPARTMENT LINEBAUGH PUMPING STATION REHABILITATION DETAILS (3)

SHEET NUMBER C - 18LAWRENCE E. MILLS, P.E. No. 22324 FILE: 13-015

CONTRACTOR SHALL TAP AND DRILL

ONE 3/4" CORPORATION STOP WITH AIR RELEASE VALVE AND PRESSURE


GAUGE ASSEMBLY. PVC PIPE AND FITTINGS (SCH80) SHALL BE PROVIDED TO DIRECT FLOW FROM THE BALL VALVE DOWNWARD TO THE FLOOR DRAIN.

3/4" BALL VALVE

#57 STONE 6"

MINIMUM THICKNESS

W/LOCKABLE OPERATOR

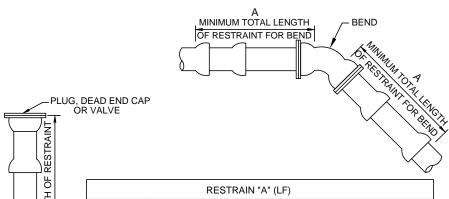

										V
RESTRAIN "A" (LF)										
	FITTING	4"	6"	8"	10"	12"	16"	18"	20"	24"
	11-1/4°	2	2	*	4	4	* 5	* 6	* 6	7
	22-1/2*	3	* 5	6	7	9	11	12	13	* 15
	45°	7	10	13	* 15	* 18	23	25	27	31
	90°	* 17	24	31	37	43	55	60	65	75
	PLUG/CAP	38	53	69	83	96	126	139	153	178

A=MINIMUM FOOTAGE OF PIPE TO BE RESTRAINED

*MINIMUM ONE PIPE JOINT UPSTREAM AND DOWNSTREAM OF EACH FITTING SHALL BE RESTRAINED

NOTES: 1. THIS TABLE IS BASED ON:

A) MAXIMUM TEST PRESSURE OF 100 psi

B) LAYING CONDITION CLASS 'C'

C) POOR SOIL CONDITIONS

D) HORIZONTAL BENDS ONLY (SEE NOTE 2)


E) LISING PV

TOTAL

- RESTRAINED LENGTHS FOR VERTICAL BENDS AND TEES ARE TO BE DETERMINED ON A CASE BY CASE BASIS, AND SPECIFIED ON THE DESIGN PLANS.
- RESTRAINING DEVICES FOR PVC PIPE SHALL BE BY MEGALUG OR EQUAL, MEETING UNI-B-13.
- 4. ANY ADDITIONAL FITTINGS WITHIN THE RESTRAINED SECTION SHALL BE RESTRAINED ACCORDINGLY.

FITTING RESTRAINT DETAIL

(AWWA C900/C905 PVC PIPE)

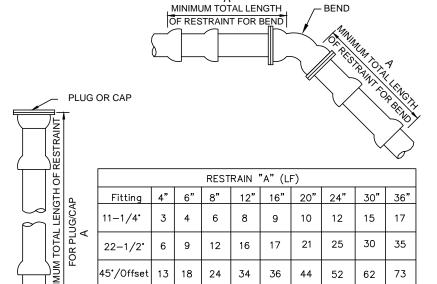

A=Minimum footage of pipe to be restrained.

102 | 143 |

82

58

NOTES: 1. This table is based on:

Plug/Cap

- a) maximum test pressure of 190 psi
- b) laying condition type 2 (see Details 2.01 and 2.02)

87

143

106

125

174 | 204 | 245 | 285

151 | 176

- poor soil conditions
- d) using D.I.P.


31

44

55 78

- e) 3 feet of cover for 12" and smaller mains; 4 feet of cover for 16" and larger mains
- f) Horizontal bends only Engineer to submit calculations for vertical restraints
- 2. For polywrapped D.I.P., multiply the footage by 1.25
- 3. For PVC pipe, multiply footage by 1.2.
- Restrained pipe shall be manufactured restrained pipe, push—on restraints or mechanical joint pipe restrained by Megalug or equivalent.
- 5. Any additional fittings within the restrained section shall

WATER PIPE RESTRAINT DETAIL

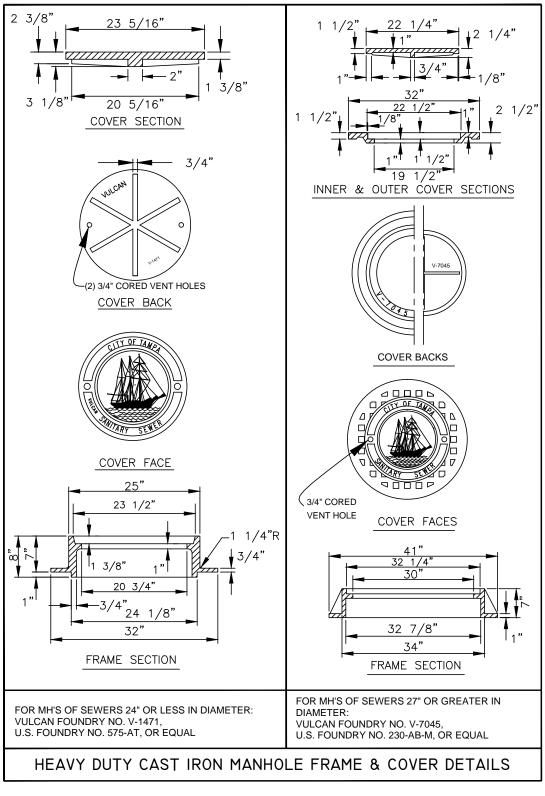

100% CONSTRUCTION DOCUMENTS -03/24/14

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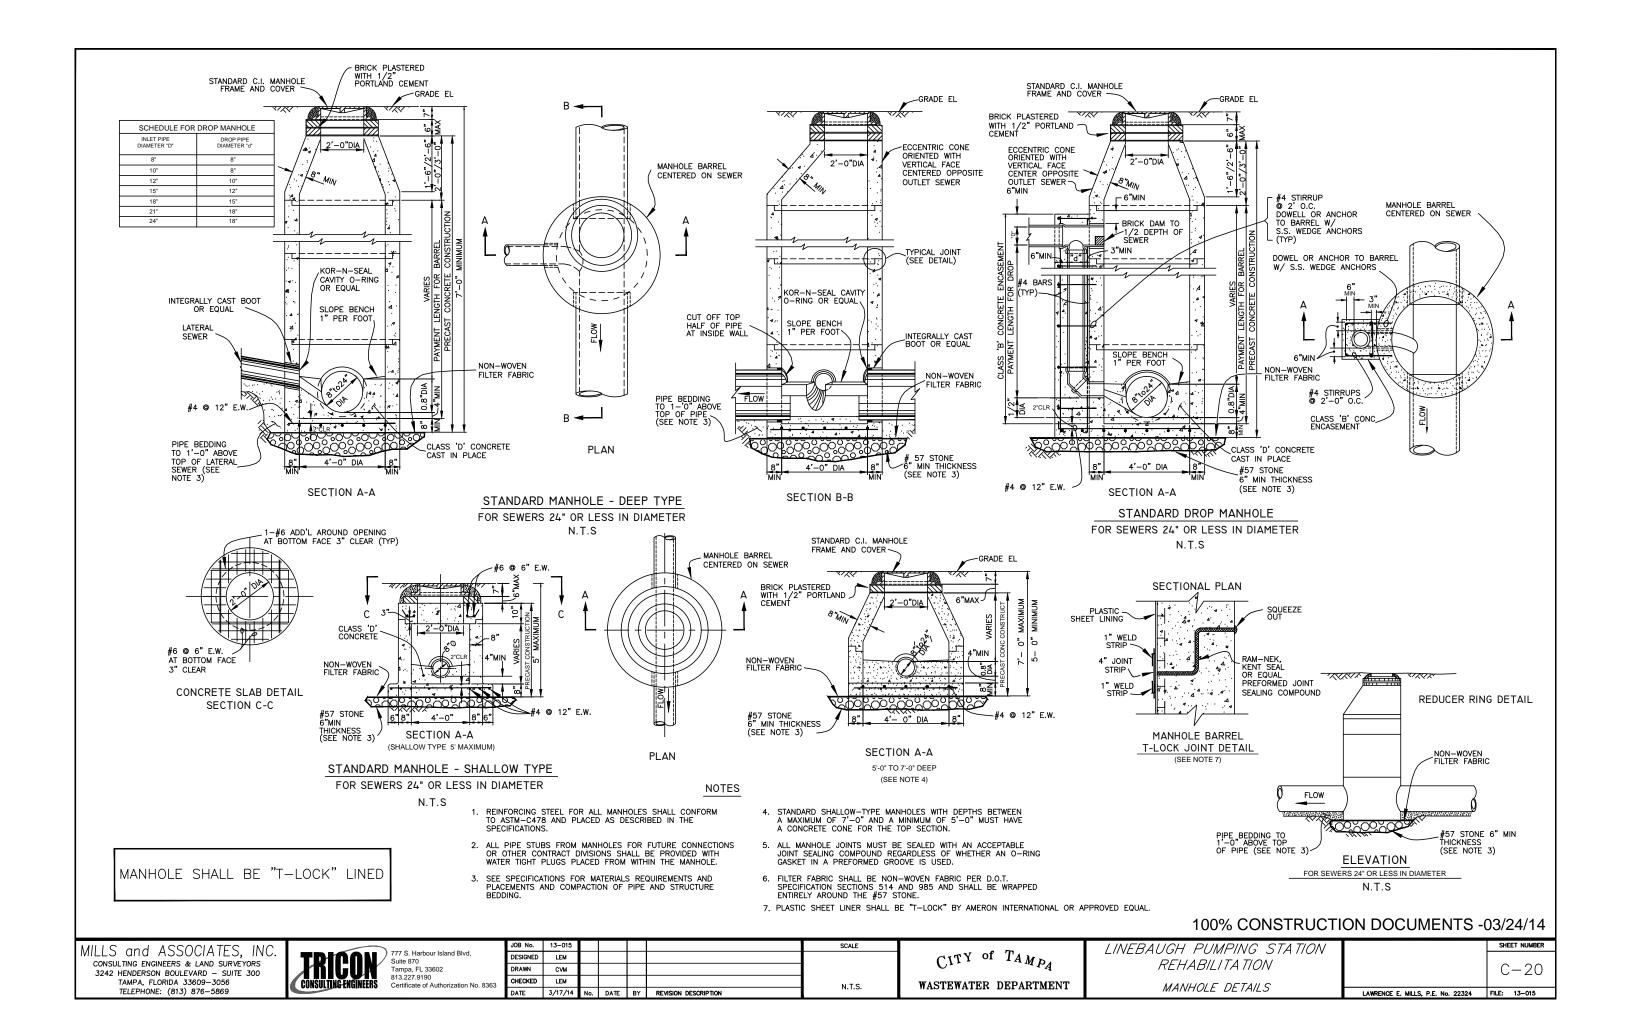



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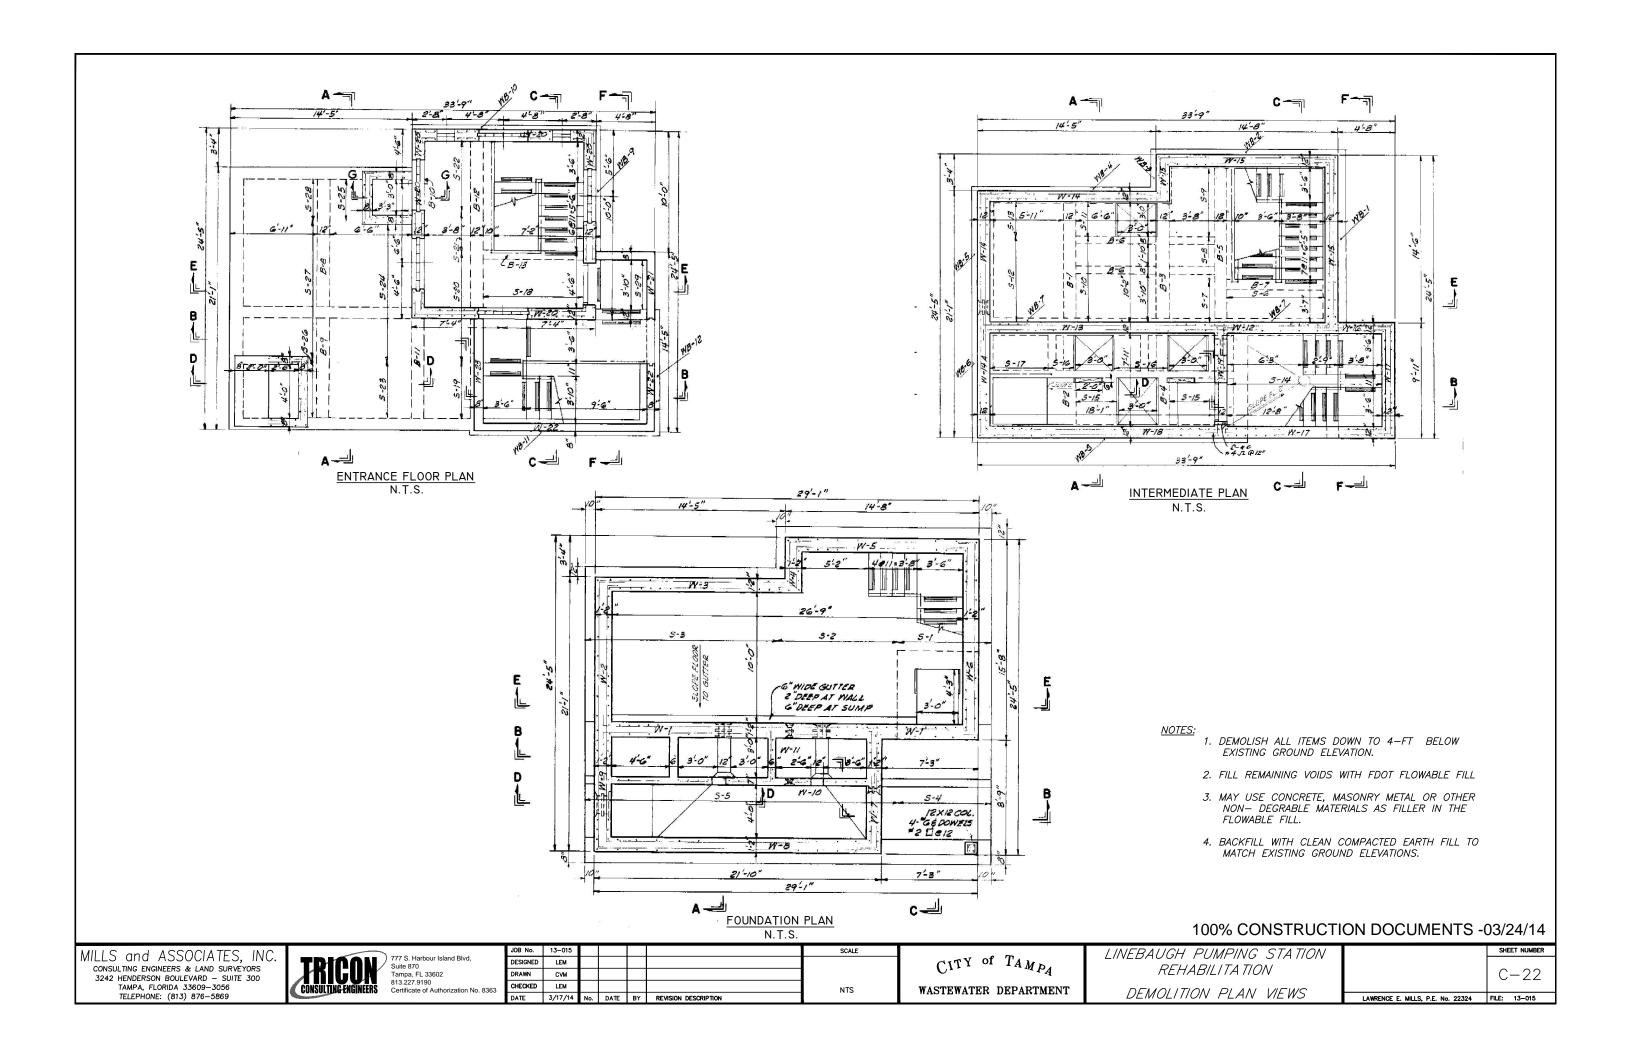
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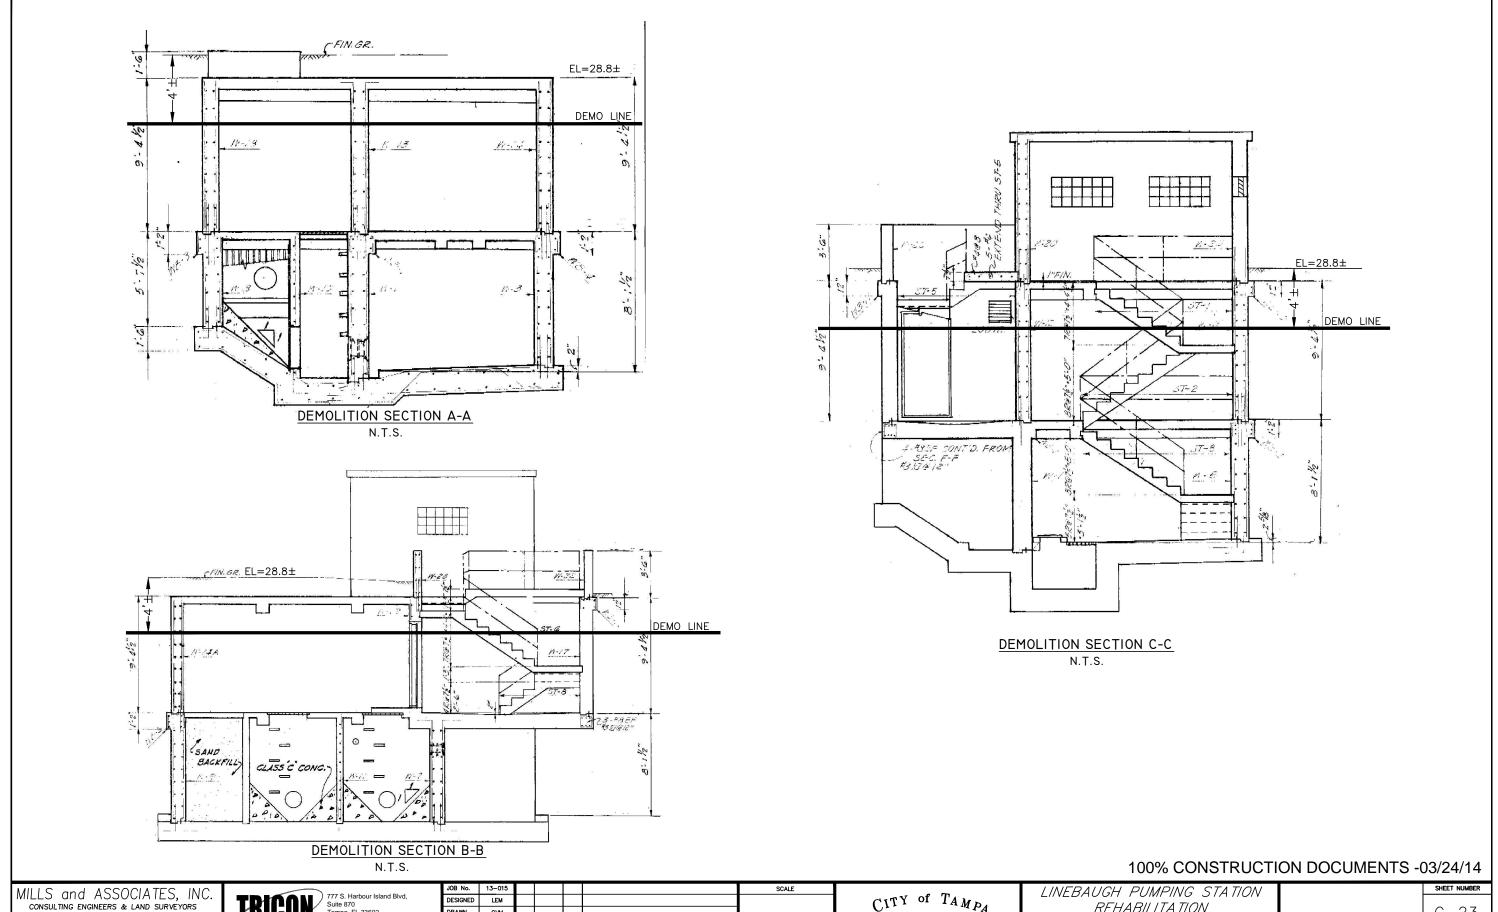
 C^{1TY} of $T_{AMP_{\mathcal{A}}}$ wastewater department

LINEBAUGH PUMPING STATION REHABILITATION DETAILS (4) SHEET NUMBER $\begin{array}{c} \text{SHEET NUMBER} \\ \\ \text{C}-19 \\ \\ \text{LAWRENCE E. MILLS, P.E. No. 22324} & \text{FILE: } 13-015 \\ \end{array}$







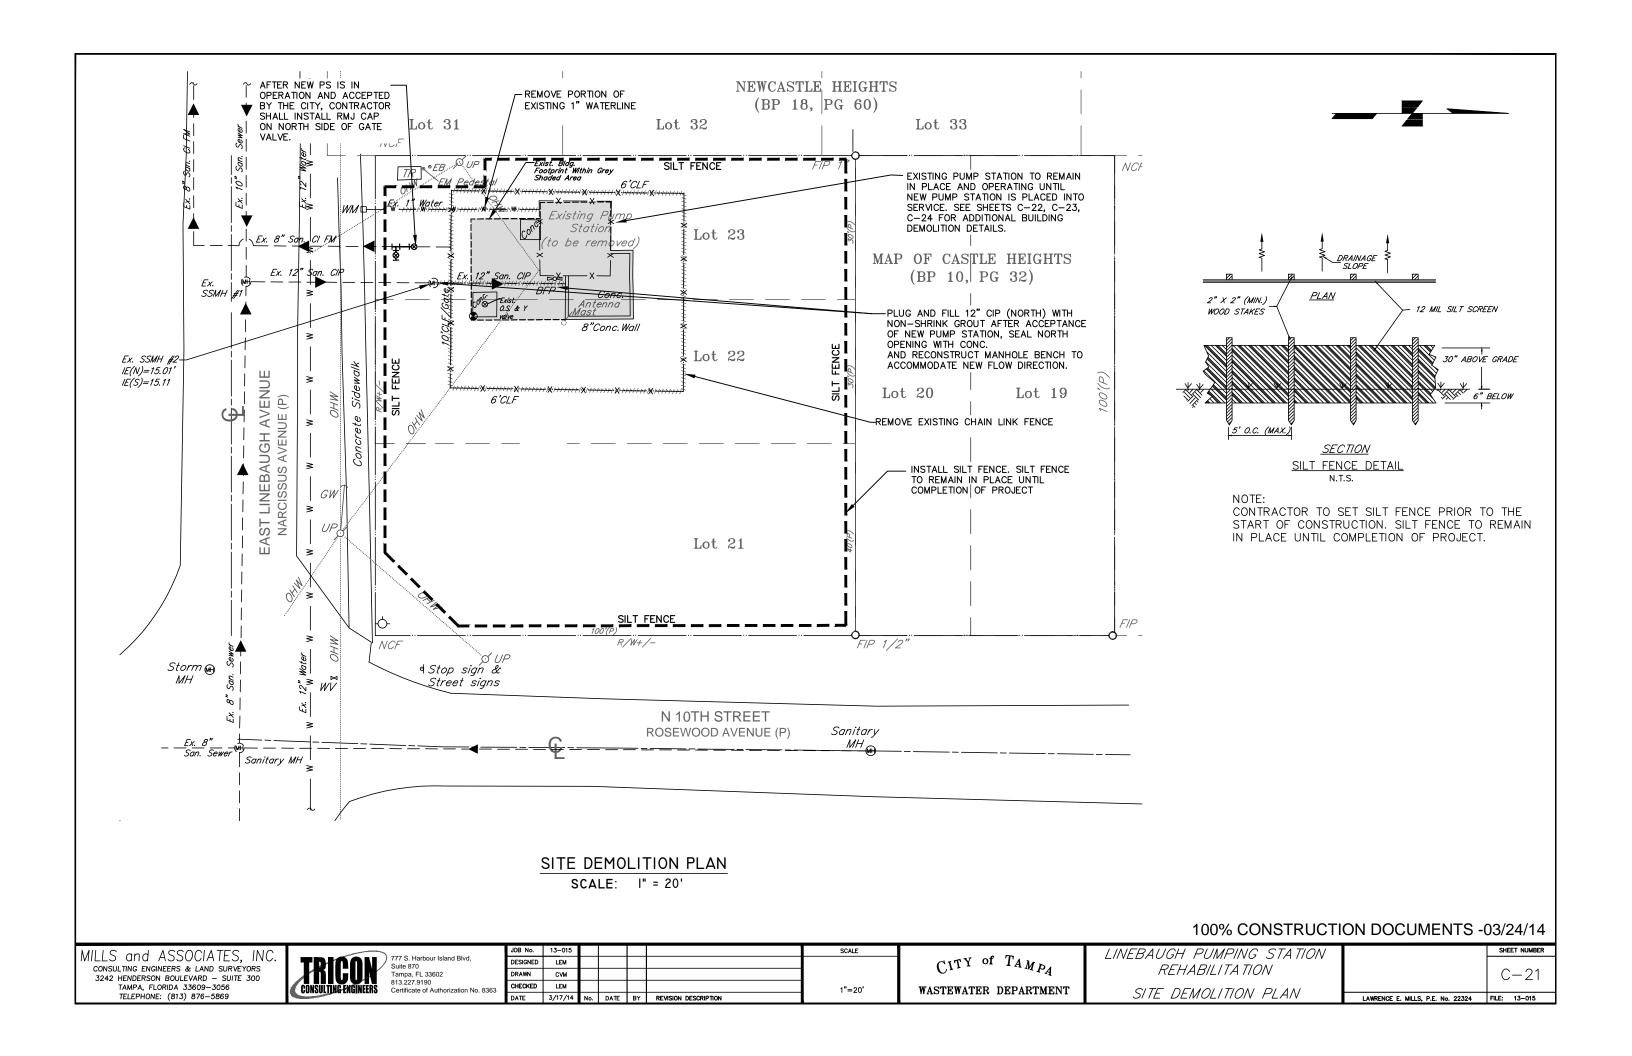

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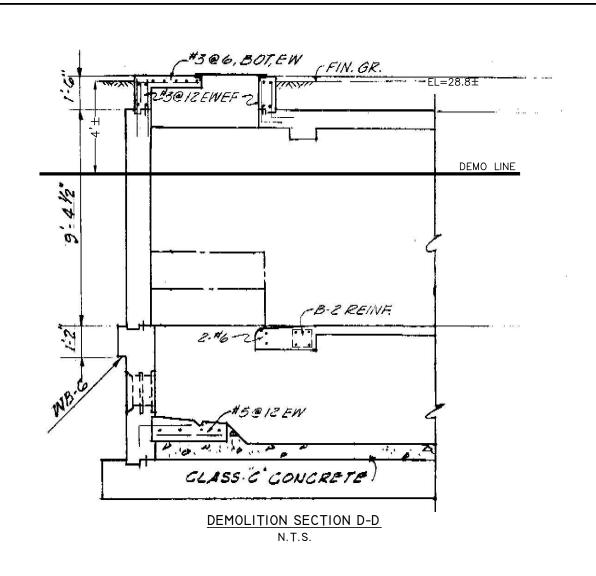
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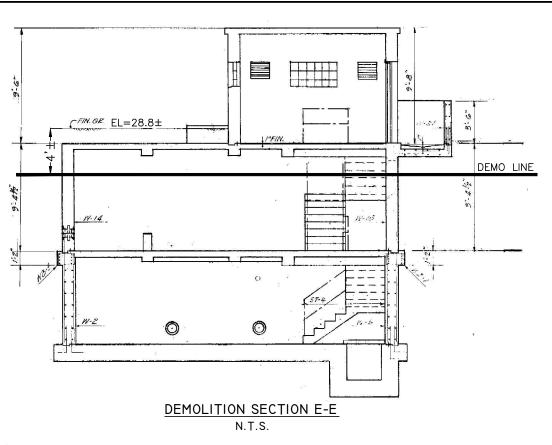
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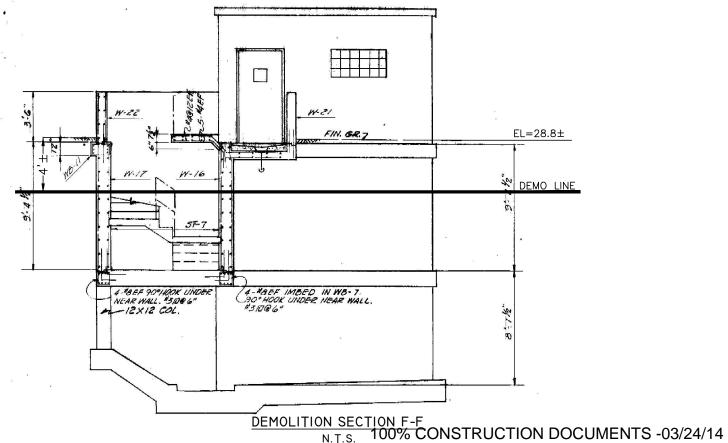
CITY of TAMPA WASTEWATER DEPARTMENT

REHABILITATION DEMOLITION SECTION VIEWS

C - 23LAWRENCE E. MILLS, P.E. No. 22324 FILE: 13-015








MILLS and ASSOCIATES, INC. consulting engineers & land surveyors 3242 Henderson Boulevard - suite 300 tampa, florida 33609-3056 telephone: (813) 876-5869


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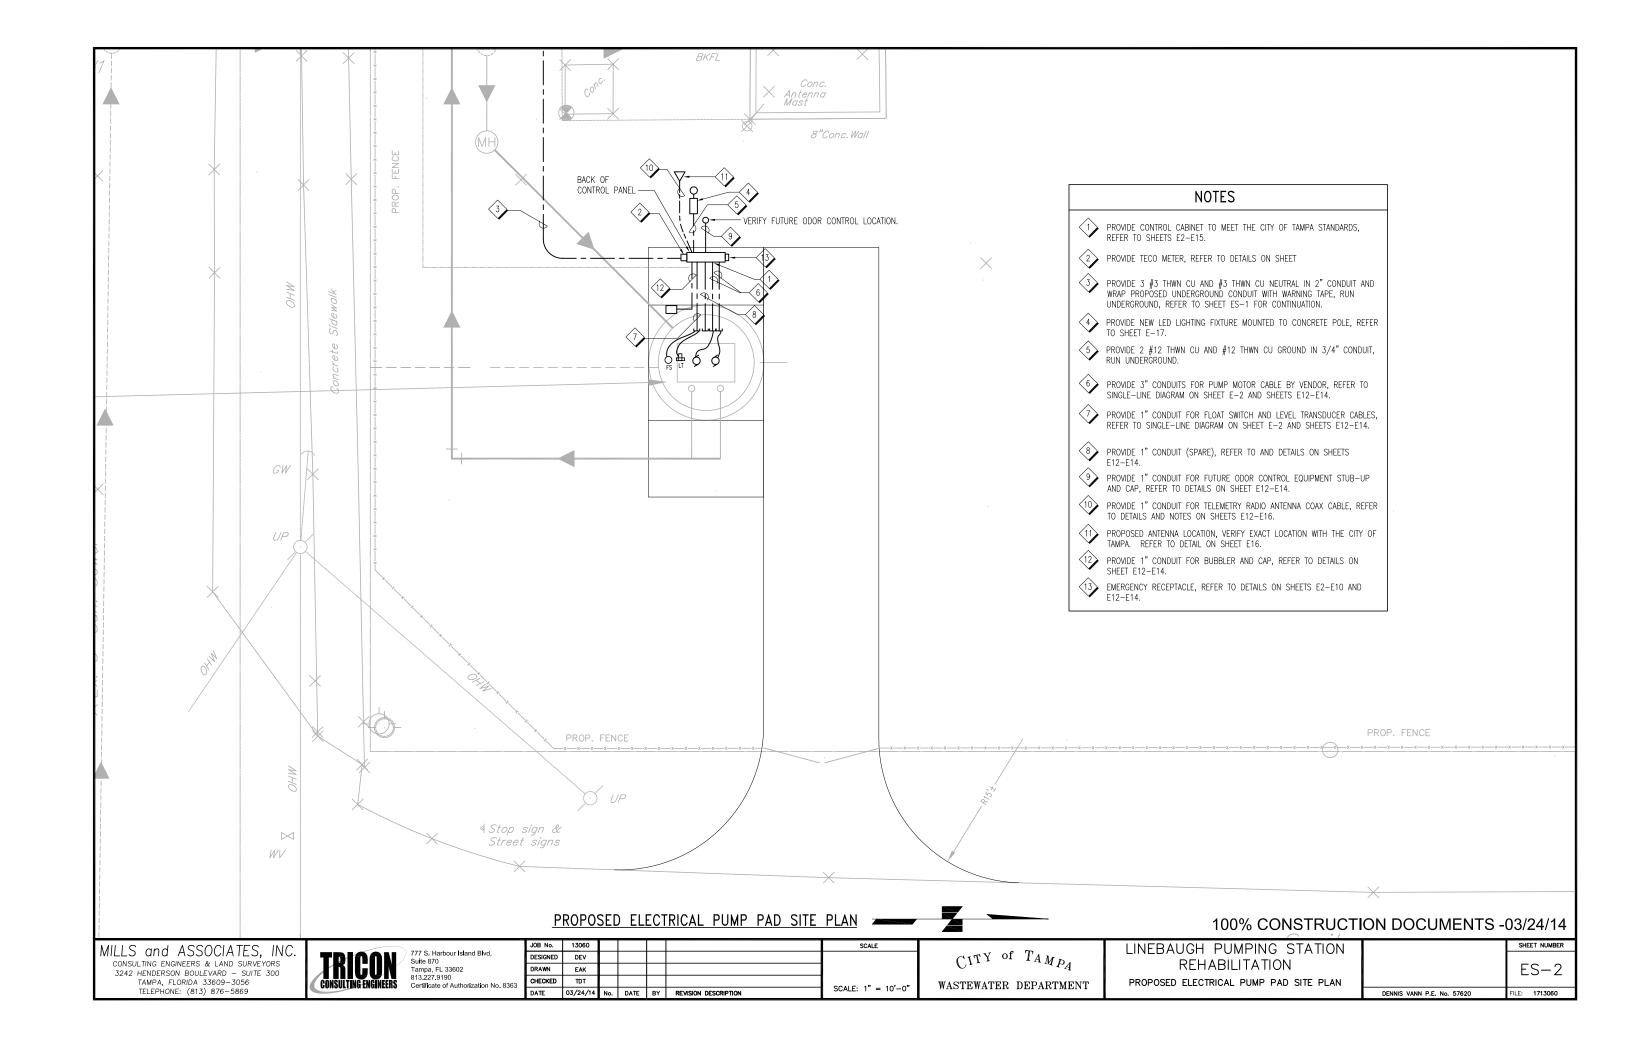
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CITY of TAMPA
WASTEWATER DEPARTMENT

LINEBAUGH PUMPING STATION REHABILITATION DEMOLITION SECTION VIEWS





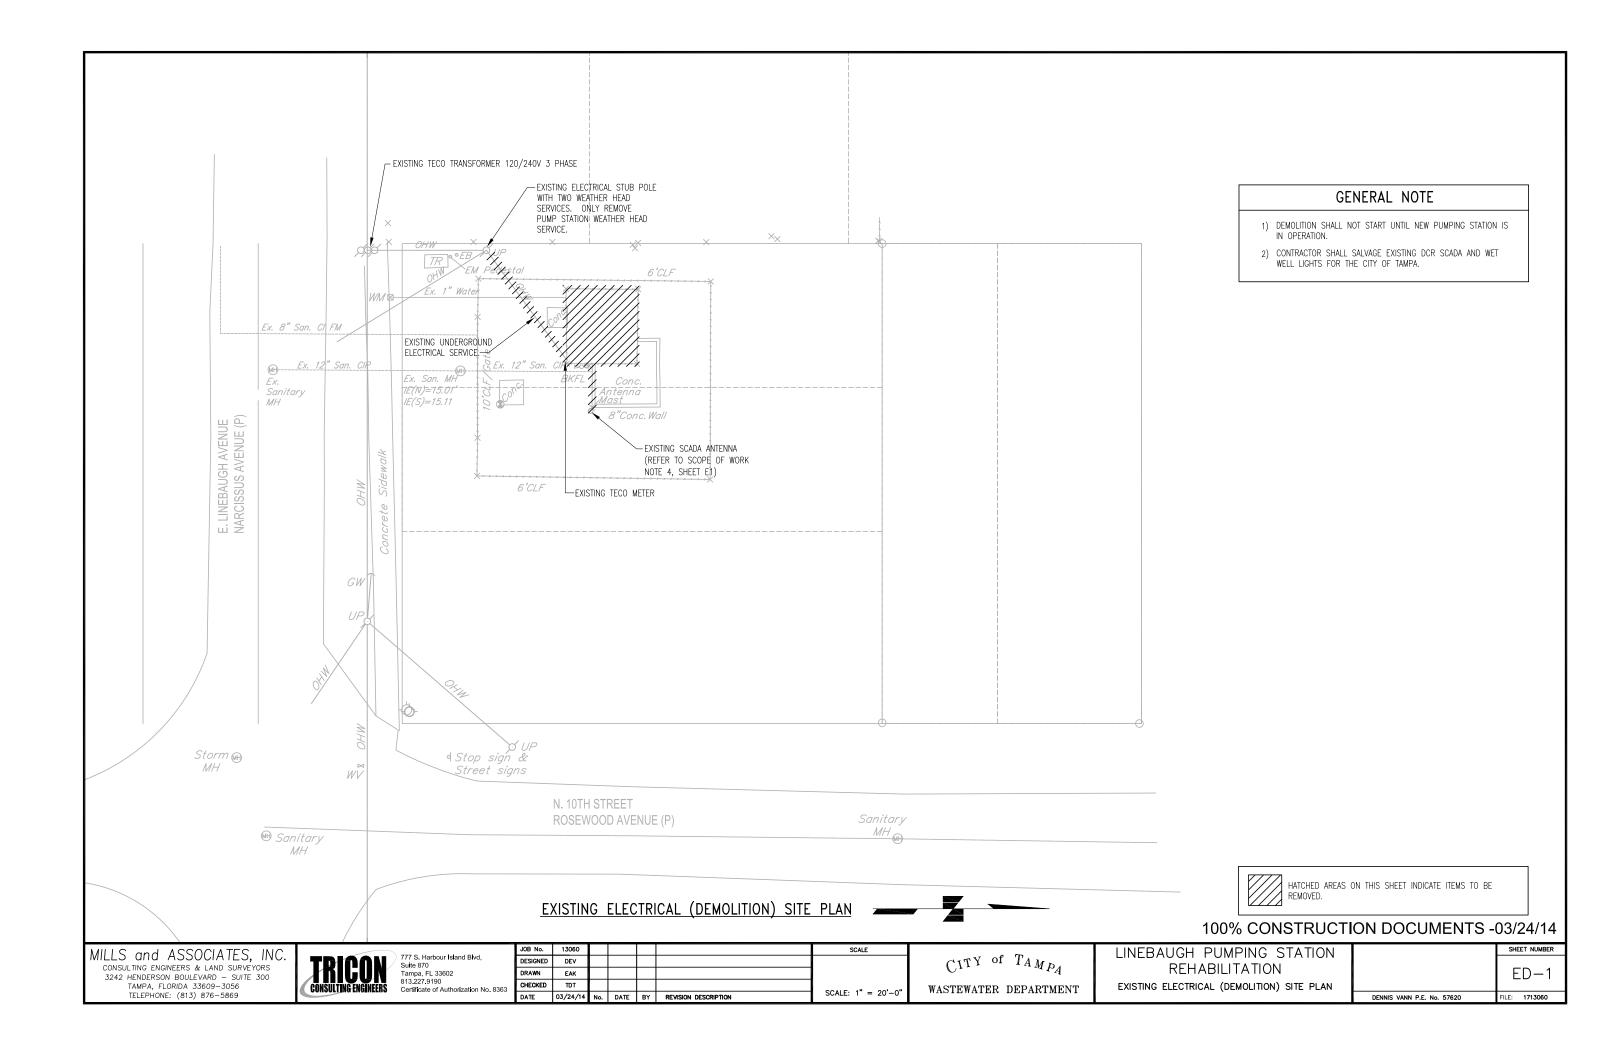

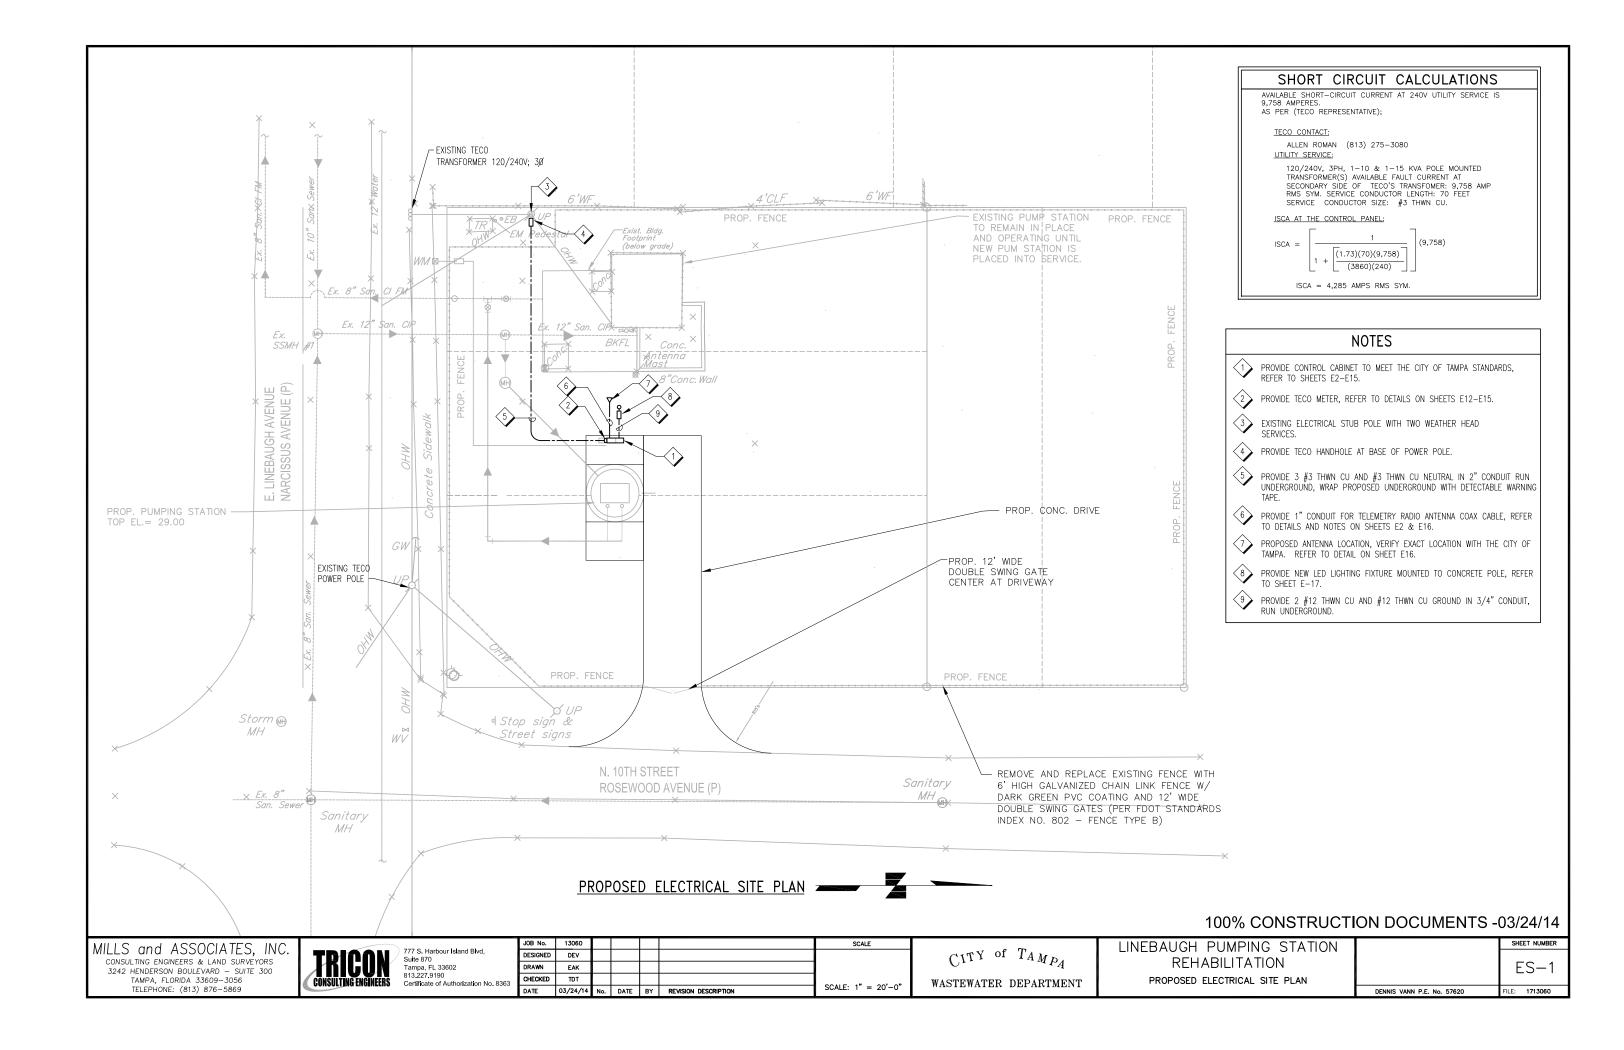GENERAL NOTES

- CONTRACTOR SHALL SUBMIT SHOP DRAWINGS FOR APPROVAL PRIOR TO PURCHASING EQUIPMENT OR COMMENCING IN CONSTRUCTION.
- ALL CONDUCTORS SHALL BE STRANDED COPPER, #12 AWG MIN. WITH THWN INSULATION, UNLESS OTHERWISE NOTED.
- 3. ALL WIRING SHALL BE IDENTIFIED WITH NUMBERS AT ALL TERMINALS AND ON WIRING DIAGRAMS.
- 4. VERIFY ALL MECHANICAL EQUIPMENT SIZES AND RATING PRIOR TO CONNECTING.
- 5. FIELD VERIFY ALL EQUIPMENT LOCATIONS AND CONNECTION PRIOR TO COMMENCING CONSTRUCTION.
- 6. ALL ELECTRICAL WORK SHALL BE PERFORMED IN ACCORDANCE WITH THE LATEST EDITION OF THE NEC AND ALL APPLICABLE LOCAL ORDINANCES.
- 7. ALL THREADED CONNECTIONS SHALL BE COATED WITH COPPER SHIELD ANTI-SEIZE COMPOUND MANUFACTURED BY THOMAS & BETTS (T & S) OR EQUAL.
- 8. ALL PANELS, DISCONNECTS, SWITCHES, AND EQUIPMENT COVERPLATES SHALL BE LABELED WITH NAMEPLATES. NAMEPLATES SHALL BE THREE-PLY PHENOLIC BLACK-WHITE-BLACK ENGRAVED THROUGH THE FIRST BLACK LAYER. LETTERING SHALL BE 0.5 CM (3/16") MINIMUM EDGE OF NAMEPLATE SHALL BE BEVELED 45 DEG.
- 9. ALL CONDUIT SHALL BE SUPPORTED AT MAXIMUM 5'-0" INTERVALS.
- 10. ALL CIRCUITS SHALL HAVE A PROPERLY SIZED GROUNDING CONDUCTOR ROUTED INSIDE EACH CONDUIT WITH POWER CONDUCTORS.
- 11. ALL CONDUCTOR LENGTHS SHALL BE CONTINUOUS, NO SPLICES OR CONDUCTOR TERMINATIONS SHALL BE PERMITTED UNLESS SPECIFICALLY DESIGNATED IN THE DRAWINGS.
- NEATLY COIL ALL SPARE CONDUCTORS AND TAPE WITH VINYL ELECTRICAL TYPE (SCOTCH 33+) POWER CONDUCTORS.
- 13. PROVIDE A MINIMUM OF 3'-6" CLEARANCE IN FRONT OF ALL ELECTRICAL EQUIPMENT IN ACCORDANCE WITH ARTICLE 110 OF THE NEC.
- 14. ALL FASTENING HARDWARE (SCREW, BOLTS, NUTS ETC.) SHALL BE 316—STAINLESS STEEL. FASTENING HARDWARE CONSTRUCTED OF FERROUS MATERIAL ARE NOT ACCEPTABLE.
- 15. EXPOSED CONDUITS SHALL BE NON-COATED RIGID ALUMINUM CONDUIT, UNLESS OTHERWISE NOTED (UON)
- 16. DIRECT BURIED AND CONCRETE ENCASED CONDUIT SHALL BE SCHEDULE 80 PVC, UNLESS OTHERWISE NOTED, WITH A TRANSITION FROM PVC TO ALUMINUM IN THE VERTICAL RUN AT LEAST FIVE FEET PRIOR TO EMERGENCE. ALL ALUMINUM SURFACES IN CONTACT WITH SOIL, CONCRETE, AND OTHER INCOMPATIBLE MATERIAL SHALL BE COATED WITH TWO COATS OF BITUMASTIC OR OTHER APPROVED INSULATING MATERIAL.
- 17. ABOVE GRADE INDOOR, AND NON-WASHDOWN AREAS, RIGID ALUMINUM CONDUIT CONNECTIONS TO CONTROL BOXES, ETC. SHALL BE MADE WITH ALUMINUM DOUBLE LOCKNUTS AND BUSHINGS. TURN DOWN ON THREADS TO SOLIDLY CONNECT RACEWAY TO BOX OR ENCLOSURE.
- 18. ALUMINUM WATERTIGHT HUBS (MYERS HUBS) SHALL BE USED FOR CONNECTIONS TO CONTROL BOXES, ETC. MOUNTED OUTDOORS, BELOW GRADE, OR IN WASHROOM AREAS.
- 19. A 316-STAINLESS STEEL CHANNEL ERECTOR SYSTEM SHALL BE USED TO SUPPORT ALL CONDUITS, BOXES ETC. USE 316-STAINLESS STEEL MOUNTING HARDWARE.
- 20. THE CONTRACTOR SHALL FIELD VERIFY EXISTING CONDITIONS AND MAKE ADJUSTMENTS AS NECESSARY TO EXECUTE THE PROPOSED INSTALLATIONS.
- 21. ALL EXISTING INSTALLATIONS DENOTED ON THE DRAWINGS ARE FOR THE CONTRACTOR'S REFERENCE ONLY. ALL EXISTING INSTALLATIONS SHALL BE FIELD VERIFIED PRIOR TO SUBMITTING A BID AND PRIOR TO COMMENCING CONSTRUCTION.
- 22. PULL BOXES SHALL BE INSTALLED AS NECESSARY TO FACILITATE WIRE PULLS AND AVOID EXCESSIVE PULLING TENSION ON WIRING. IN NO CASE SHALL CONDUIT LENGTHS EXCEED 150' OF THE EQUIVALENT OF FOUR-QUARTER BENDS (360' TOTAL) WITHOUT A PULL BOX. PULL BOXES SHALL BE SIZED IN ACCORDANCE WITH ARTICLE 314 OF THE NEC.

SCOPE OF WORK

- 1. THE CONTRACTOR SHALL COORDINATE ELECTRICAL SERVICE REQUIREMENTS WITH TAMPA ELECTRIC COMPANY (TECO). THE CITY WILL MAKE PRELIMINARY ARRANGEMENTS WITH TECO AND COMPENSATE THE UTILITY DIRECTLY FOR ANY CONTRIBUTION IN AID OF CONSTRUCTION (CIAC) REQUIRED FOR TECO TO INSTALL A HAND HOLE AT THE BASE OF THE EXISTING STUB POLE. THE EXISTING 120/240 VAC, 3-PHASE, 4-WIRE, DELTA SERVICE SHALL REMAIN. AFTER NEW PUMPING STATION IS COMPLETED AND ACCEPTED, THE EXISTING METER SOCKET, LIGHTNING ARRESTOR, AND SERVICE RISER/WEATHERHEAD SHALL BE REMOVED. THE FOLLOWING EQUIPMENT SHALL BE PROVIDED AND INSTALLED; ELECTRICAL METER SOCKET, LIGHTNING ARRESTOR, AND GROUNDING AS SHOWN ON PLANS. PROVIDE AND INSTALL UNDERGOUND CONDUIT/CONDUCTORS EXTENDING FROM THE PROPOSED TECO HAND HOLE TO THE PROPOSED METER.
- 2. COORDINATE REMOVAL OF THE OLD WEATHER HEAD SERVICE RISER, POLE SHALL REMAIN AS SHOWN
- 3. DISCONNECT AND REMOVE THE EXISTING POWER CONTROL CENTER (PCC), DISC. SWITCH, MOTORS, LIGHTING AND VENTILATION EQUIPMENT MOUNTED INSIDE THE EXISTING PUMP STATION.
- 4. CAREFULLY REMOVE THE EXISTING DCR SCADA RTU CABINET MOUNTED ON ANTENNA. DELIVER THIS RTU PACKAGE TO THE CITY TO MAINTENANCE INVENTORY.
- 5. ANY SALVAGEABLE MATERIALS, AS DETERMINED BY THE CITY OF TAMPA ENGINEER, SHALL BE DELIVERED, BY THE CONTRACTOR, TO THE HOWARD F. CURRENT AWT. PLANT. THE CONTRACTOR SHALL PROPERLY DISPOSE OF ALL OTHER REMOVED EQUIPMENT.
- 6. PREPARE THE SITE FOR THE INSTALLATION OF THE PROPOSED PUMP CONTROLS/SCADA/RADIO (PCSR) FNCI OSURE.
- 7. PROVIDE AND INSTALL A NEW DUPLEX PUMP CONTROL PANEL. THE CONTROL PANEL SHALL CONTAIN CONTROL COMPONENTS, INDICATOR LIGHTS, CIRCUIT BREAKERS, AND MOTOR STARTERS AS SHOWN ON THE PLANS AND DETAILED IN THE SPECIFICATIONS.
- 8. RELOCATE EXISTING, OR PROVIDE AND INSTALL NEW, SCADA ANTENNA/ MAST AS SHOWN OR REQUIRED.
- CALIBRATE AND ADJUST SETPOINTS AND ALL SENSING DEVICES, ALARM DEVICES, AND TIMERS.
 CALIBRATIONS AND SETPOINTS SHALL BE PROVIDED IN ACCORDANCE WITH MANUFACTURE'S
 RECOMMENDATIONS.
- 10. PROVIDE AND INSTALL ALL NECESSARY CONDUITS AND CONDUCTORS AS SHOWN ON THE PLANS, UNLESS NOTED OTHERWISE.
- 11. FURNISH AND INSTALL A JUNCTION BOX CONSTRUCTED OF SHEET ALUMINUM WITH LOUVERED OPENINGS ON A CONCRETE PEDESTAL, AS SHOWN ON THE PLANS.
- 12. PROVIDE FOR PROPER GROUNDING AS SHOWN, SPECIFIED, AND REQUIRED.
- 13. ALL ELECTRICAL WORK SHALL BE PERFORMED IN ACCORDANCE WITH THE LATEST EDITION OF THE NATIONAL ELECTRIC CODE ADOPTED BY THE STATE OF FLORIDA AND CHAPTER 5 OF THE CITY OF TAMPA CODE.

PUMP MOTOR DATA

MAKE: ITT

MODEL: NP3127.185

HP: 10

240 V, 3 PHASE, 25.0 FLA

TOTAL PUMP LOAD: 50 AMPS, 20.8 KVA

100% CONSTRUCTION DOCUMENTS -03/24/14

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CONSULTING ENGINEERS & LAND SURVEYORS
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TAMPA, FLORIDA 33609-3056
TELEPHONE: (813) 876-5869



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JOB No.	13060					SCALE
DESIGNED	DEV					
DRAWN	EAK					i
CHECKED	TDT					
DATE	03/24/14	No.	DATE	BY	REVISION DESCRIPTION	NTS


 C^{1TY} of $T_{AMP_{\mathcal{A}}}$ wastewater department

LINEBAUGH PUMPING STATION
REHABILITATION
GENERAL NOTES AND SCOPE OF ELECTRICAL WORK

SHEET NUMBER

E — 1

DENNIS VANN P.E. No. 57620 FILE: 1713060

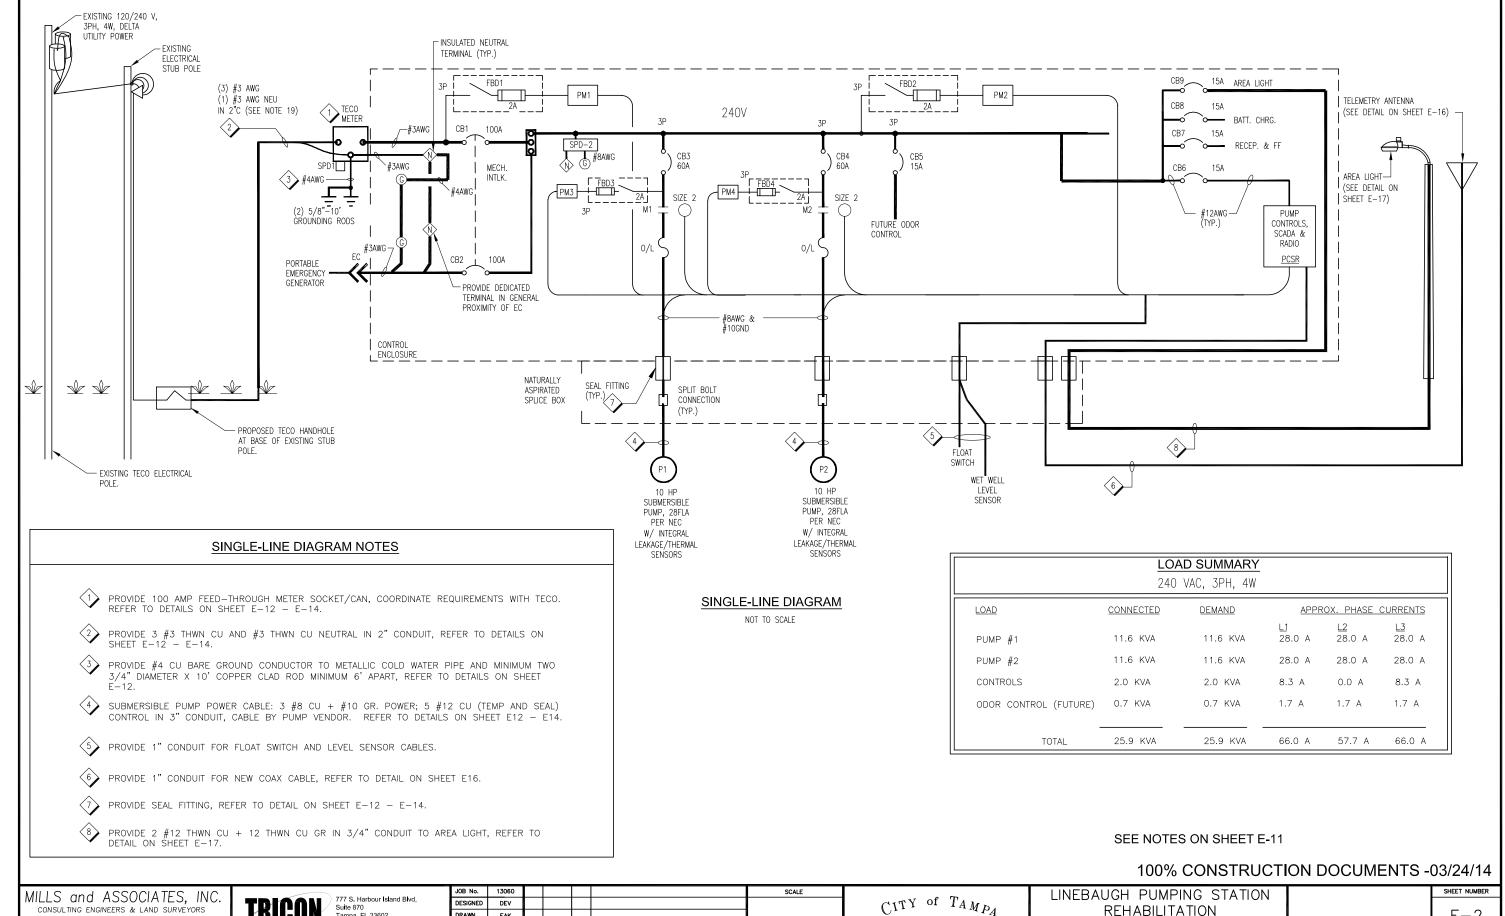

3242 HENDERSON BOULEVARD - SUITE 300 TAMPA, FLORIDA 33609-3056 TELEPHONE: (813) 876-5869


Tampa FI 33602

DRAWN FAK CHECKED TDT DATE 03/24/14

NTS No. DATE BY REVISION DESCRIPTION

CITY of TAMPA WASTEWATER DEPARTMENT REHABILITATION ONE LINE DIAGRAM

DENNIS VANN P.E. No. 57620

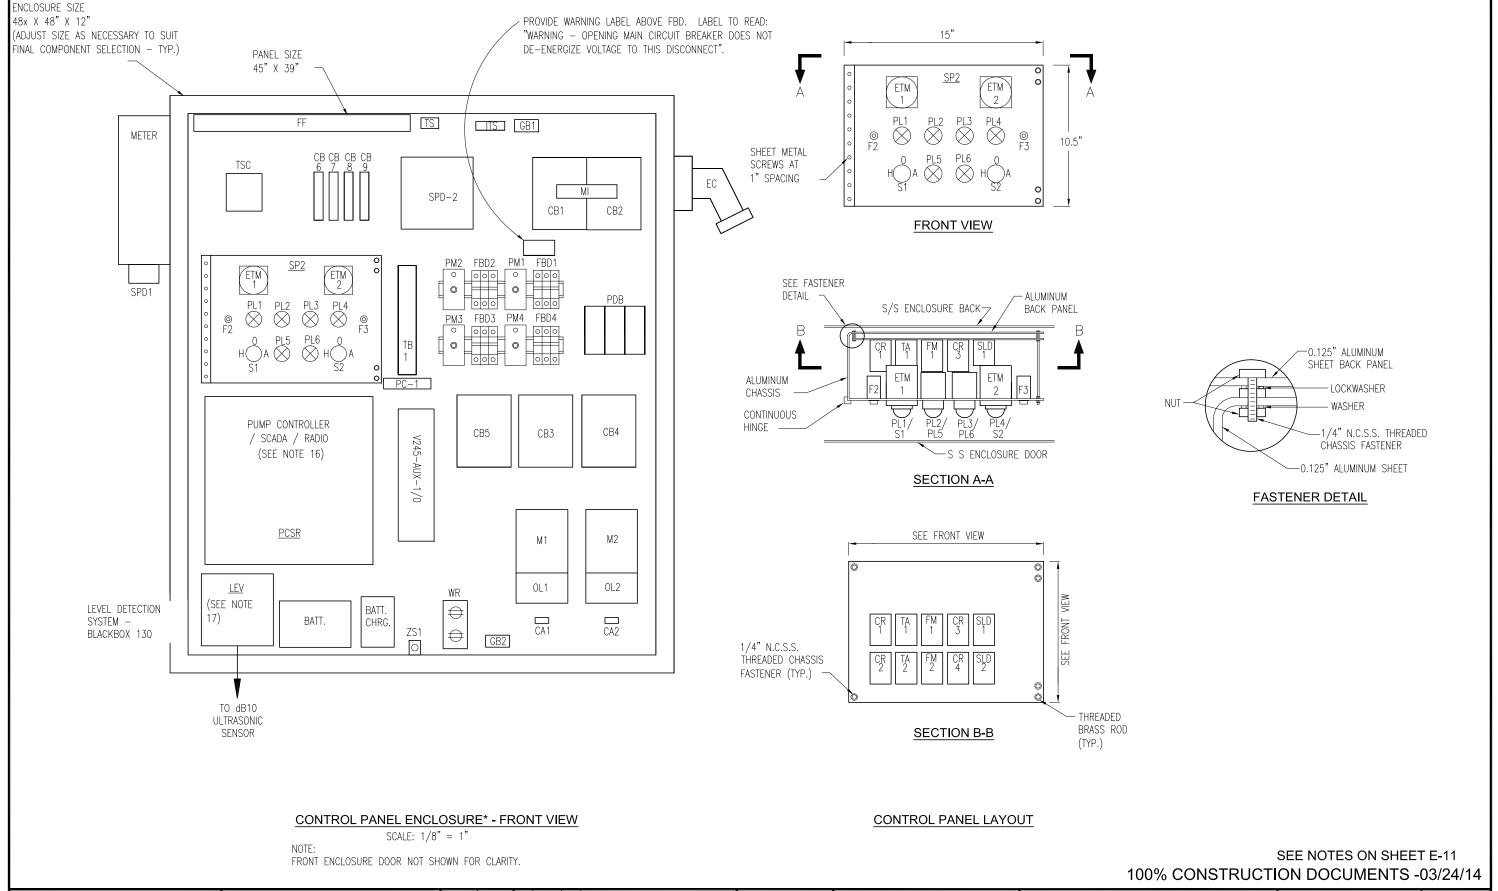

MILLS and ASSOCIATES, INC.
CONSULTING ENGINEERS & LAND SURVEYORS
3242 HENDERSON BOULEVARD - SUITE 300
TAMPA, FLORIDA 33609-3056
TELEPHONE: (813) 876-5869

TRICON CONSULTING ENGINEERS

777 S. Harbour Island Blvd, Suite 870 Tampa, FL 33602 813,227,9190 Certificate of Authorization No. 8363

 C^{1TY} of $T_{AMP_{\mathcal{A}}}$ Wastewater department LINEBAUGH PUMPING STATION
REHABILITATION
PROPOSED ELECTRICAL CONTROL PANEL LAYOUT

SHEET NUMBER

E — 3

DENNIS VANN P.E. No. 57620 FILE: 1713060

CVAROL	NAME		DEMARKS			
SYMBOL	NAME	MAKE	TYPE	MODEL OR CAT. #	RATING	— REMARKS
CB 1	CIRCUIT BREAKER	SQUARE D	THREE POLE	HDL 34100	480 V, 100 A	25 KAIC @ 240VAC
CB 2	CIRCUIT BREAKER	SQUARE D	THREE POLE	HDL 34100	480 V, 100 A	20 17/10 9 210/70
CB 3, 4	CIRCUIT BREAKER	SQUARE D	THREE POLE	HDL 32060	240 V, 60A	
CB 5	CIRCUIT BREAKER	SQUARE D	THREE POLE	HDL 32015	240 V, 15A	
CB 6, 7, 8, 9	CIRCUIT BREAKER	SQUARE D	SINGLE POLE	Q0U-115	120 V, 15A	
M1, 2	MOTOR STARTER	SQUARE D	NEMA SIZE 2	CLASS 8536 TYPE SD01V02	120 V, (COIL)	15 HP (MAX) 1 N.O.
OL 1, 2	OVERLOAD RELAY	SQUARE D	BIMETALLIC, AMBIENT COMPENSATED	AR51	25-26.9	
CA1, CA2	CIRCUIT SENSOR	ENERCORP INSTRUMENTS	4-20 mA OUTPUT	SC200-1	0 - 50A	ADJUSTABLE RANGE
PL1, PL4	INDICATOR LIGHT	SQUARE D	CLASS 9001	SKT - 38LYA9	120 V, LED TYPE	YELLOW LENS & PRESS TEST
PL5, PL6	INDICATOR LIGHT	SQUARE D	CLASS 9001	SKT – 38LRR9	120 V, LED TYPE	RED LENS & PRESS TEST
	03 /24/14					
PL2, PL3	ILLUM. PUSH BUTTON	SQUARE D	CLASS 9001	SK2L38LRRH13	120 V, LED TYPE	RED LENS & INO, INC
S1, S2	HOA SWITCH ASSEMBLY	SQUARE D	OIL-TIGHT CLASS 9001	SKS - 43B H2	10A @ 120V	
ETM1, ETM2	ELAPES TIME METER	CRAMER	NON-RESET	635E&S	120 V	W.W. GRANGER CAT. NO. 6X14
ZS1	CONTROL PNL INTRUSION SENSOR	OMRON	CYLINDRICAL, SHORT BARREL	E2f-X5E1 (GRAINGER-6C826)	10-30VDC, 3-WIRE PNP	W/ SQUARE D MTG. BRACKET (GRAINGER — 5B233)
FF & TS	FLUORESCENT FIXTURE	DAYTON	INDUSTRIAL	2 V 811	120 V 20w	W/TOGGLE SWITCH-TS AND TUBE GUARD
WR	WALL RECEPTACLE	HUBBELL	DUPLEX W/GFI	GF5262	120V AC, 15A GFI	W/UTILITY BOX AND COVER
EC	EMERGENCY CONNECTOR	CROUSE & HINDS	ARKTROL	AR-1047-S22 w/AJA6 ANGLE ADAPTER	600 V, 100 A	MALE
SPD-2	SURGE PROTECTIVE DEVICE TYPE 1	ADVANCED PROTECTION TECHNOLOGIES	MAIN PANEL SPD-2	TEO3XDS104X	120/240 V, 3Ø DELTA	
MI	MECHANICAL INTERLOCK	CUTLER-HAMMER	SLIDING BAR TYPE	SBK1		INTERLOCK CB-1 & 2
MS	METER SOCKET	MILBANK	7-TERMINAL W/BYPASS	UAP3506-XL-TG-HSP	600 VAC, 125A	ALUM. CONTRUCTION

PARTS SCHEDULE IS CONTINUED ON NEXT SHEET.

- ALARM FLOAT SWITCH WILL BE SUPPLIED BY WWD AND INSTALLED BY CONTRACTOR.
- 2. DIMENSIONS, ITEMS, OR ELEVATIONS MARKED "*" SHALL BE DETERMINED AFTER EQUIPMENT SELECTION.

100% CONSTRUCTION DOCUMENTS -03/24/14

MILLS and ASSOCIATES, INC. CONSULTING ENGINEERS & LAND SURVEYORS
3242 HENDERSON BOULEVARD — SUITE 300
TAMPA, FLORIDA 33609—3056
TELEPHONE: (813) 876—5869



TRICON 500 Suite 870 Tampa, FL 33602 813,227,9190 Certificate of Authorization No. 8363

JOB No.	13060					SCALE
DESIGNED	DEV					
DRAWN	EAK					
CHECKED	TDT					
DATE	03/24/14	No.	DATE	BY	REVISION DESCRIPTION	NTS

CITY of TAMPA WASTEWATER DEPARTMENT LINEBAUGH PUMPING STATION REHABILITATION PARTS SCHEDULE (1 OF 2)

	SHEET NUMBER	
	E-4	
DENNIS VANN P.E. No. 57620	FILE: 1713060	

		P	ARTS SCHEDULE (C	ONT.)		
SYMBOL	NAME		PA	RT		REMARKS
STIVIDOL	NAME	MAKE	TYPE	MODEL OR CAT. #	RATING	REWARKS
FL	FLOAT SWITCH	ANCHOR SCIENTIFIC	SPDT	S20NONC	10 A @ 120 V	
SPD1	LIGHTNING ARRESTOR	GENERAL ELECTRIC	TRANQUEL	9L 15 ECC 001	650 V	
TB 1	TERMINALS	PHOENIX CONTACT		UK5N TERMINALS	30 A W/ ALUM. DIN RAIL	41 CONTACTS (MIN)
ITS	INSULATED TERMINAL STRIP	ALLEN-BRADLEY	STYLE AA	1492-15-T	600 V AC NEUTRAL BLOCK	4 CONTACTS (MIN) W/ SHORTING BARS
ME	CONTROL ENCLOSURE *	QUALITY METALS	NEMA 3 THREE POINT LATCH	48"x42"x12" SS 3R	304 SS, 14 GAUGE	TWO DOORS W/STOP KITS
MP	ENCLSURE PANEL *	QUALITY METALS	45" X 39", STEEL		STEEL, 12 GAUGE	#A-DSTOPK. EXTERNAL FINISH DURABLE RAL 9003 WHITE POWER COAT.
GB 1, 2	GROUNDING BLOCK	ILSCO	AS REQUIRED	AS REQUIRED		
SLD1, SLD2	SEAL LEAK DETECTOR	SYRELEC	8 PIN PLUG-IN	PNRV110	110V INPUT, 10A CONTACT	SPDT W/ SOCKET
TA1, TA2, FM1, FM2, CR1, CR2, CR3, CR4	CONTROL RELAY	POTTER & BRUMFIELD	8 PIN PLUG-IN	KRPA-11AG-120	120V COIL, 10A CONTACTS	DPDT W/ SOCKET AND HOLD DOWN SPRING
LEV	WET WELL LEVEL SENSOR	PULSAR, INC.	ULTRASONIC	dB10 TRANSDUCER W/ BLACKBOX 130 TRANSMITTER PART #: 130-110-300-00P-KP-TROP	1 TD 32.8 FT RANGE 115VAC/24VDC POWERED W/ 4-20MA AND (2) RELAY OUT W/ KEY PAD, DISPLAY, AND TROPICALIZATION	CITY FORCES WILL PROVIDE ASSISTANCE WITH MOUNTING AND CALIBRATION
PCSR	PLC BASED PUMP CONTROLLER,	MOTOROLA CORP.	DUPLEX PUMP CONTROLLER BASED	ACE 3600 W/ UHF RADIO	1-AC POWER SUPPLY 85-264V	COORDINATE EFFORT W/
SLOTS 1 & 2	SCADA, AND RADIO SYSTEM	MOTOROLA CORP.	ON ACE 3600 PROGRAM CONTROLLER 1- MIXED I/O AUXILLARY INTERFACE	CDM 750, 403-512 MHz PART #: F7564 1-40 WIRE CABLE W/TB HOLDER	W/ BAT CHARGER PAR #: V261 1- ACE CPU3640 PART #: V446	SCADA INTEGRATOR 1- 10.0 Ah BATTERY
02070 1 0 2	1-3 I/O SLOT FRAM PART #: V103	1-20 PIN TB HOLDER KIT PART #: V158	BOARD PART #: V245-AUX-I/O 1- 14x 14 METAL CHASSIS PART #: V214	3M PART #: V358 2-16DI, 4DO(EE), 20mA MODULE PART #: V245	1-40 PIN TB HOLDER KIT PART #: V153	PART #: V328
PM1, PM2, PM3, PM4	3-PHASE POWER MONITOR	MOTOR CONTROLS CORP.	8 PIN PLUG-IN	PM-230-118A	230 VAC	W/ OPTIONAL 5—SEC RELEASE AND DIN RAIL SOCKET
PDB	PWR DIST. BLOCK	ILSC0	THREE POLE	PDB-26-2/0-3	600 V, 350 AMP	W/ LEXAN COVER
FBD1, FBD2, FBD3, FBD4	FUSE BLOCK / DISCONNECT	ALLEN BRADLEY	THREE PHASE- HIGH INTER. CAP.	1492-FB3C30-L	600 VAC, 200KAIC	W/ BUSSMANN KTK-R-2 FAST ACTING, REJECTION FUSES
BATT.	BATTERY	POWERSONIC	ABSORBENT GLASS MAT (AGM)	PS-1270 F2	12 VOLT, 7.0 AH	W/ 0.25" x 0.032" TABS
BATT. CHRG.	BATTERY CHARGER	DELTRAN CORP.	BATTERY TENDER	WATERPROOF 800	120VOLT, 800 mADC	QUALIFICATION, BULK, & FLOAT CHARGING
PC-1	BACKUP PUMP CONTROLLER	DCR ENGG. OR WILKERSON	DUPLEX LIFT STATION	BR560 OR DR1920	10 AMP CONTACTS	DIN RAIL MOUNTING

100% CONSTRUCTION DOCUMENTS -03/24/14

MILLS and ASSOCIATES, INC.

CONSULTING ENGINEERS & LAND SURVEYORS

3242 HENDERSON BOULEVARD - SUITE 300

TAMPA, FLORIDA 33609-3056

TELEPHONE: (813) 876-5869



TRICON 777 S. Harbour Island Blvd, Suite 870 Tampa, Fl. 33602 813.227,9190 Certificate of Authorization No. 8363

	JOB No.	13060					SCALE
- 1	DESIGNED	DEV					
	DRAWN	EAK					
	CHECKED	TDT					
	DATE	03/24/14	No.	DATE	BY	REVISION DESCRIPTION	NTS

CITY of TAMPA WASTEWATER DEPARTMENT LINEBAUGH PUMPING STATION REHABILITATION PARTS SCHEDULE (2 OF 2)

	SHEET NUMBER
	E-5
DENNIS VANN P.E. No. 57620	FILE: 1713060

DIMENSIONS, ITEMS, OR ELEVATIONS MARKED "*" SHALL BE DETERMINED AFTER EQUIPMENT SELECTION.

LEGEND PLATE SCHEDULE				
SYMBOL	DEVICE	LEGEND		
ETM1	ELAPSED TIME METER	PUMP NO. 1 HOURS		
ETM2	ELAPSED TIME METER	PUMP NO. 2 HOURS		
PL1	YELLOW PILOT LIGHT	PUMP NO. 1 ON		
PL2	RED ILLUMINATED PUSH BUTTON	PUMP NO. 1 HIGH TEMPERATURE AND RESET		
PL3	RED ILLUMINATED PUSH BUTTON	PUMP NO. 2 HIGH TEMPERATURE AND RESET		
PL4	YELOW PILOT LIGHT	PUMP NO. 2 ON		
PL5	RED PILOT LIGHT	PUMP NO. 1 SEAL LEAK		
PL6	RED PILOT LIGHT	PUMP NO. 2 SEAL LEAK		
S1	3 POSITION SWITCH	PUMP NO. 1 HAND-OFF-AUTO		
S2	3 POSITION SWITCH	PUMP NO. 2 HAND-OFF-AUTO		

100% CONSTRUCTION DOCUMENTS -03/24/14

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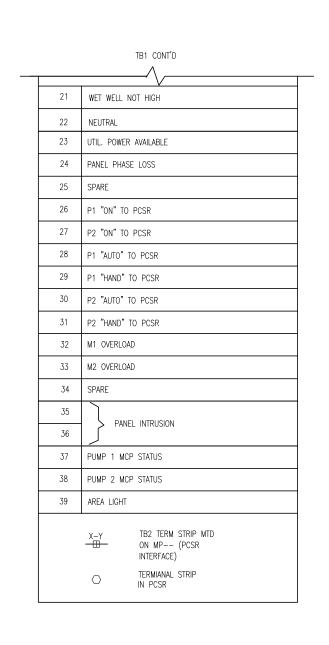
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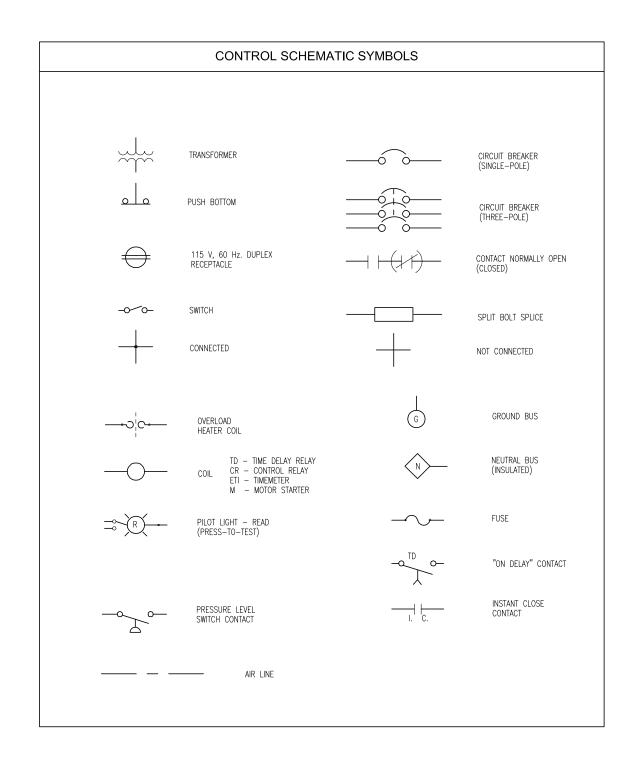
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	DESIGNED	DEV					
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3	CHECKED	TDT					
_	DATE	03/24/14	No.	DATE	BY	REVISION DESCRIPTION	NTS

CITY of TAMPA WASTEWATER DEPARTMENT LINEBAUGH PUMPING STATION REHABILITATION ELECTRICAL CONTROLS LEGEND PLATES

E-6DENNIS VANN P.E. No. 57620 FILE: 1713060

ТВ-	1 () MOUNTED ON MAIN PANEL (MP)
TERM.	DESCRIPTION
1	CB6 OUT PUMPS CONTROL POWER
2	PUMP 1 FAULT CONTROL INTERLOCK
3	PUMP 2 FAULT CONTROL INTERLOCK
4	SLOT 1 PCSR 24V+
5	STATOR TEMP. SWITCH FROM P1
6	START TEMP SWITCH FROM P2
7	7
8	ODOR CONTROL BLOWER (FUTURE)
9	
10	PUMP 1 AMPS
11	PUMP 2 AMPS
12	P1 SEAL LEAK
13	PROBE
14	P2 SEAL LEAK
15	PROBE
16	P1 "ON" DISC.
17	M1 "RUN" CMD
18	M2 "RUN" CMD
19	P2 "ON" DISC.
20	WET WELL HIGH





SEE NOTES ON SHEET E-11

100% CONSTRUCTION DOCUMENTS -03/24/14

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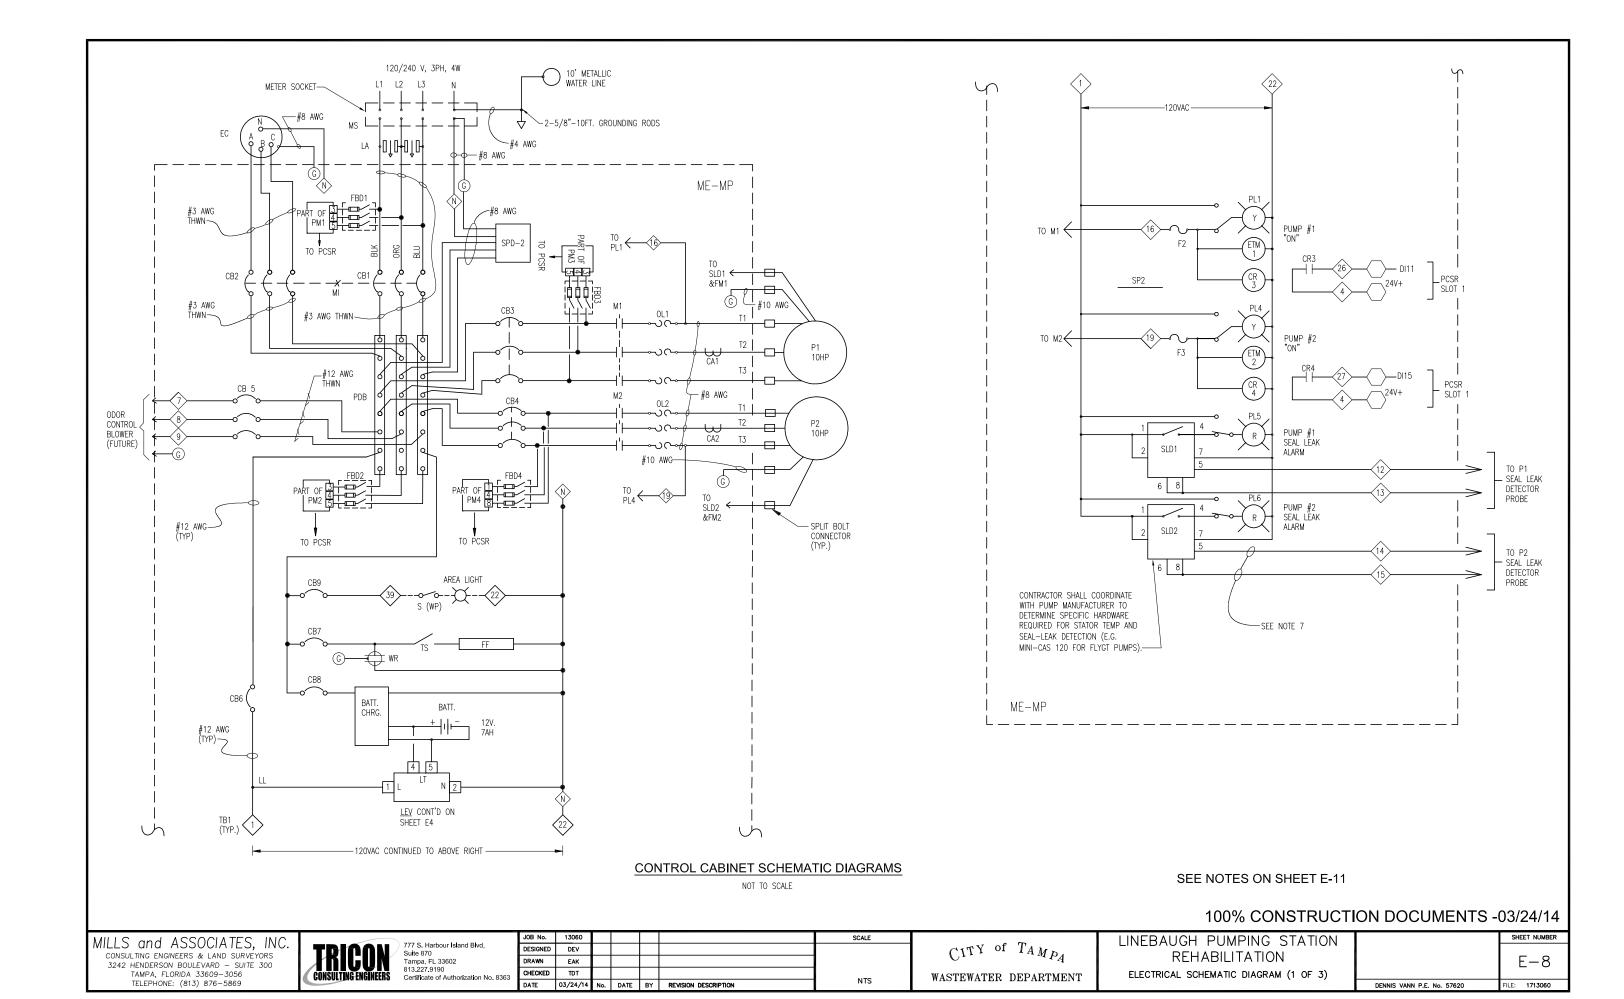
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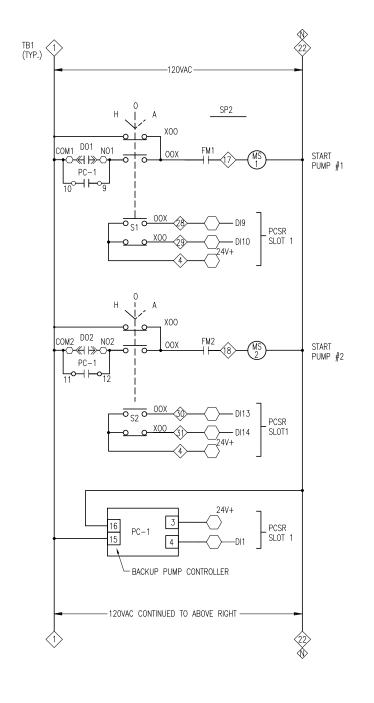
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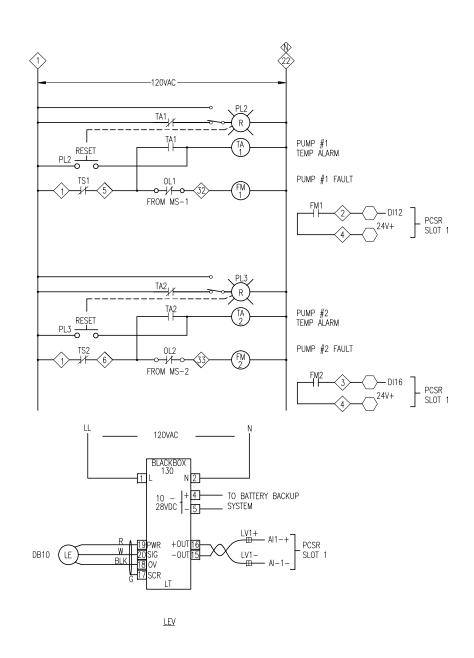
 $_{C1}^{TY}$ of $T_{A}{}_{M}{}_{P_{A}}$ wastewater department

LINEBAUGH PUMPING STATION
REHABILITATION
ELECTRICAL SCHEMATIC LEGEND

	SHEET NUMBER	
	F-7	
	_ ′	ı
DENNIS VANN P.E. No. 57620	FILE: 1713060	ı







CONTROL CABINET SCHEMATIC DIAGRAMS

NOT TO SCALE

SEE NOTES ON SHEET E-11

100% CONSTRUCTION DOCUMENTS -03/24/14

MILLS and ASSOCIATES, INC.

CONSULTING ENGINEERS & LAND SURVEYORS

3242 HENDERSON BOULEVARD — SUITE 300

TAMPA, FLORIDA 33609—3056

TELEPHONE: (813) 876—5869




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LINEBAUGH PUMPING STATION
REHABILITATION
ELECTRICAL SCHEMATIC DIAGRAM (2 OF 3)

	SHEET NUMBER
	E-9
DENNIS VANN P.E. No. 57620	FILE: 1713060



NOTES

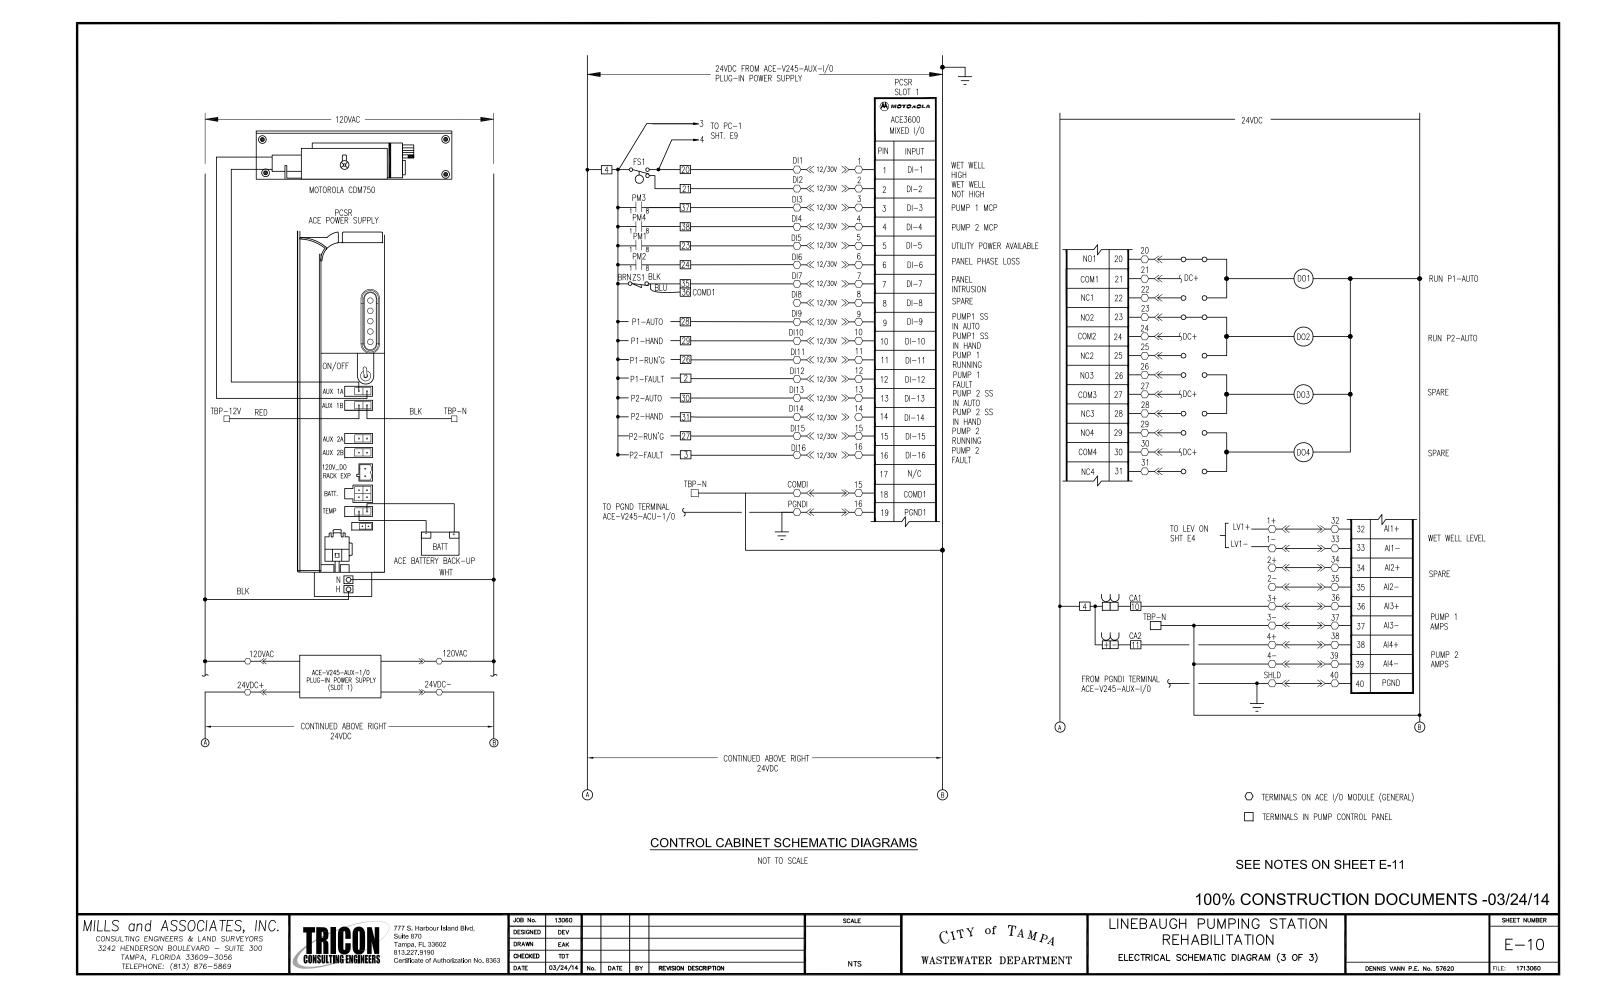- 1. TECO SERVICE: PROP 120/240V, 3Ø, 4W, DELTA CALCULATED FAULT CURRENT 9,758 AMPS AT TRANSFORMERS; PROPOSED 100 AMP, CB1 AIC RATING - 25,000A SYMMETRICAL.
- 2. THE WET WELL CLASSIFICATION IS CLASS I, DIVISION 2, GROUP D, (HAZARDOUS AREA) NEC CHAPTER 5 IS APPLICABLE FOR INTERFACING WET WELL AND THE CONTROL ENCLOSURE.
- 3. ALL ELECTRICAL WORK SHALL BE PERFORMED WITHIN LATEST NEC AND CITY OF TAMPA/ HILLSBOROUGH COUNTY CODES AND SHALL BE INSPECTED BY CITY OF TAMPA/ HILLSBOROUGH COUNTY ELECTRICAL INSPECTORS AS APPLICABLE.
- 4. ALL ELECTRICAL COMPONENTS SHALL BE UL LISTED AND AS SPECIFIED, OR AS APPROVED BY THE ENGINEER. THE PANEL BUILDER SHALL BE UL-508 CERTIFIED AND A UL LABEL SHALL BE ATTACHED TO THE INSIDE OF THE ENCLOSURE. ALSO LABEL THE PANEL —— "SUITABLE FOR USE AS SERVICE EQUIPMENT".
- 5. THE ENCLOSURE SHALL BE NEMA 3, SHALL BE CONSTRUCTED OF MINIMUM 14 GAUGE 304 SS, SHALL HAVE RAL 9003 WHITE POWDER COAT SURFACE, AND THE CLOSING SURFACE SHALL HAVE ROLLED LIPS, PROVIDE HINGED DOOR WITH 3—POINT LATCH AND LOCKABLE HANDLE. REFERENCE PARTS SCHEDULE.
- 6. ALL COMPONENTS TO BE MOUNTED ON PANEL USING TAPPED HOLES.
- 7. ALL WIRING SHALL BE COPPER, ALL CONTROL WIRING SHALL BE STRANDED THWN COPPER, MINIMUM AWG # 14, AND SHALL HAVE SPADE LUG TERMINATIONS.
- 8. ALARM FLOAT SWITCH WILL BE SUPPLIED BY THE CITY, BUT INSTALLED BY CONTRACTOR.
- 9. DIMENSIONS, ITEMS, OR ELEVATIONS MARKED '*' TO BE DETERMINED AFTER EQUIPMENT SELECTION.
- 10. ALL MECHANICAL CONNECTORS SHALL BE TORQUED PER NEC, UL OR MANUFACTURERS SPECIFICATIONS.
- 11. INSTALL LAMINATED SCHEMATIC AND LAMINATED DATA SHEET ON BACK FACE OF THE DOOR INSIDE THE ENCLOSURE.
- 12. ENSURE THAT LINE CONNECTIONS TO METER SOCKET PROVIDE CORRECT METER ROTATION.
- 13. ROUTE AND SECURE SERVICE ENTRANCE CONDUCTORS SO AS NOT TO INTERFERE WITH OR CONTACT EQUIPMENT AND COMPONENTS IN THE PANEL. ALSO, PROVIDE SPACING BETWEEN THE ENCLOSURE AND ALL CONDUCTORS.
- 14. CONDUCTORS WITHIN THE ENCLOSURE AND NOT ROUTED IN WIREWAYS, SHALL BE SECURED TO THE BACKPANEL WITH MECHANICAL FASTENERS, FASTENERS SECURED WITH ADHESIVE ARE NOT ACCEPTABLE.
- 15. ALL HINGED SURFACES SHALL BE GROUNDED WITH A BONDING JUMPER SECURED TO THE ENCLOSURE OR BACKPANEL.
- 16. THE PSCR SHALL BE A MOTOROLA ACE 3600 PACKAGE AS DISTRIBUTED BY DCR ENGINEERING SERVICES INC., SCADAONE, LLC., OR REVERE CONTROL SYSTEMS. THE PUMPING STATION CONTRACTOR SHALL COORDINATE HIS EFFORTS WITH DCR, SCADAONE, OR REVERE CONTROL SYSTEMS TO ENSURE SYSTEM COMPATIBILITY. THE CONTRACTOR SHALL PROVIDE AND INSTALL A COMPLETE DUPLEX CONTROL SYSTEM/SCADA PACKAGE, AS PROGRAMMED BY DCR, SCADAONE, OR REVERE CONTROLS THE EXISTING PUMPING STATION DCR CONTROLS SHALL REVERT TO THE CITY AS A SPARE.
- 7. A WET WELL LEVEL DETECTION SYSTEM SHALL BE PROVIDED AND INSTALLED BY THE CONTRACTOR. THE OUTPUT SHALL BE A LINEAR 4-20mA SIGNAL WITH RANGE AND CALIBRATION SUITABLE FOR THIS APPLICATION. THE SYSTEM SHALL BE OF THE ULTRASONIC TYPE-- PULSAR, INC. MODEL dB10 W/BLACKBOX 130 TRANSMITTER. CITY INSTRUMENTATION PERSONNEL WILL ASSIST THE CONTRACTOR WITH SPECIFYING THE TRANSDUCER MOUNTING LOCATION AND CALIBRATION. THE DB10 TRANSDUCER SHALL BE MOUNTED USING A 2 1/2" x 1/4" S.S. BRACKET, SEE DB10 MOUNTING BRACKET DETAIL, SHEET E14.
- 18. PROVIDE 1/4" MINIMUM THICKNESS LEXAN SHIELDS OVER POWER DISTRIBUTION BLOCK AND OTHER EXPOSED CABLE TERMINATIONS.
- 19. PROPOSED 2" CONDUIT SHALL BE SCHEDULE 80 PVC AND SHALL BE A MINIMUM 24" IN DEPTH BETWEEN THE TOP SURFACE OF FINISH GRADE AND TOP SURFACE OF CONDUIT. CONDUIT ROUTE SHOWN IS APPROXIMATE, ADJUST TO FIELD CONDITIONS.

100% CONSTRUCTION DOCUMENTS -03/24/14

MILLS and ASSOCIATES, INC.
CONSULTING ENGINEERS & LAND SURVEYORS
3242 HENDERSON BOULEVARD - SUITE 300
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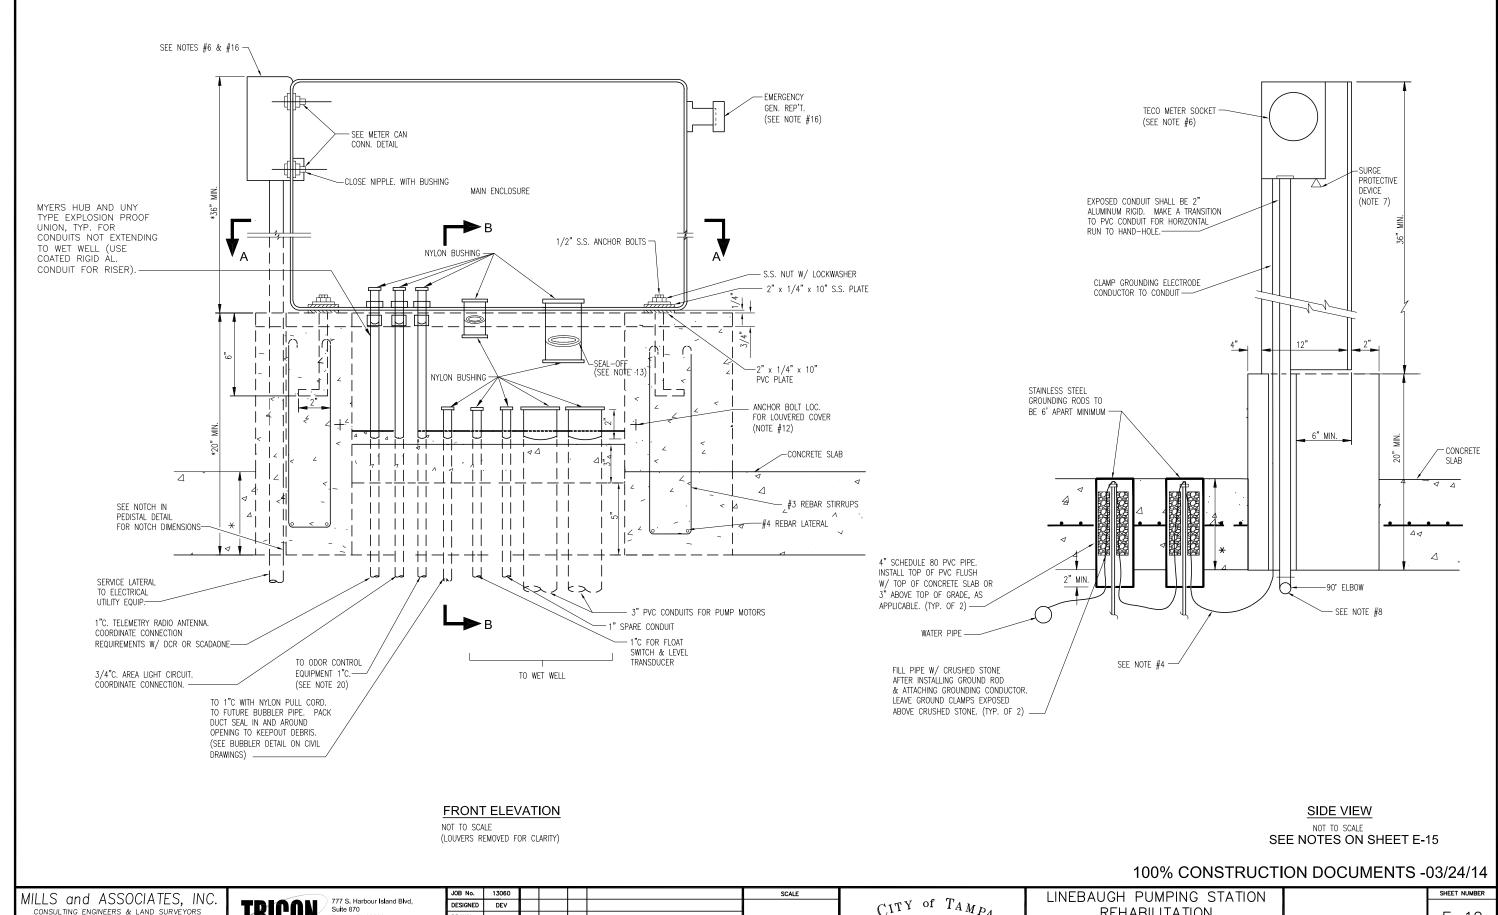
 C^{1TY} of $T_{AMP_{\mathcal{A}}}$ wastewater department

LINEBAUGH PUMPING STATION
REHABILITATION
ELECTRICAL NOTES FOR SHEETS E2 - E10

SHEET NUMBER

E-11

DENNIS VANN P.E. No. 57620 FILE: 1713060



CONSULTING ENGINEERS & LAND SURVEYORS 3242 HENDERSON BOULEVARD - SUITE 300 TAMPA, FLORIDA 33609-3056 TELEPHONE: (813) 876-5869

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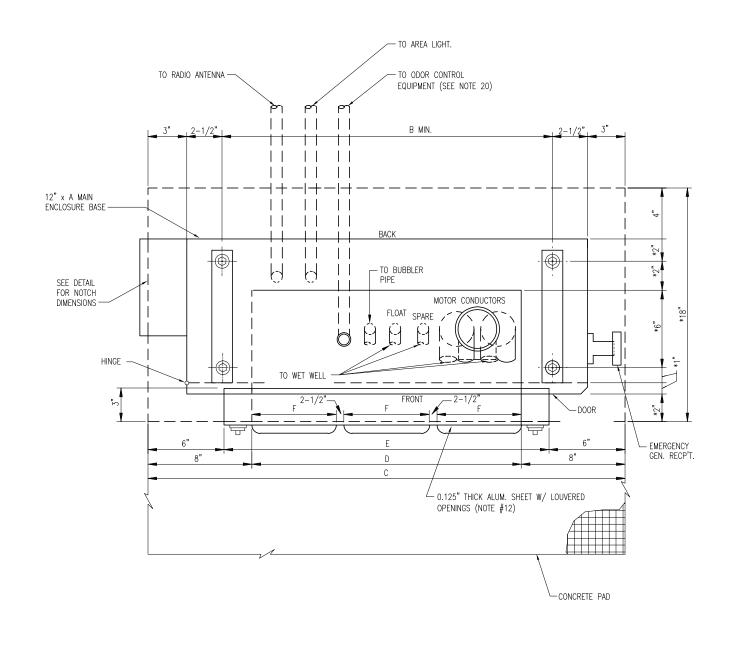
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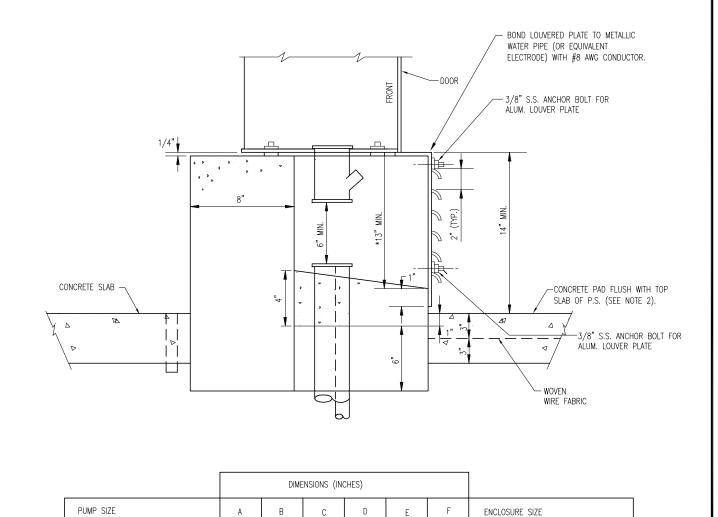
CITY of TAMPA NTS DATE 03/24/14 No. DATE BY REVISION DESCRIPTION

WASTEWATER DEPARTMENT

REHABILITATION ELECTRICAL PEDESTAL DESIGN (1 OF 2)

E - 12DENNIS VANN P.E. No. 57620





SECTION A-A

NOT TO SCALE

SECTION B-B

43

48

NOT TO SCALE

SEE NOTES ON SHEET E-15

100% CONSTRUCTION DOCUMENTS -03/24/14

48"H x 48"W x 12"D

MILLS and ASSOCIATES, INC. consulting engineers & land surveyors 3242 henderson boulevard - suite 300 tampa, florida 33609-3056 telephone: (813) 876-5869

TRICON CONSULTING ENGINEER

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 C^{1TY} of $T_{AMP_{A}}$ WASTEWATER DEPARTMENT


10.0 HP @ 240V.


LINEBAUGH PUMPING STATION
REHABILITATION
ELECTRICAL PEDESTAL DESIGN (2 OF 2)


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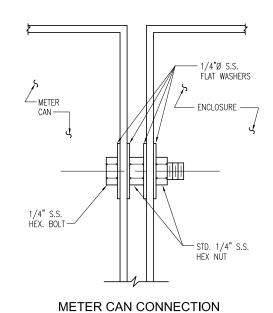
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SHEET NUMBER E-13 Dennis vann p.e. no. 57620 File: 1713060





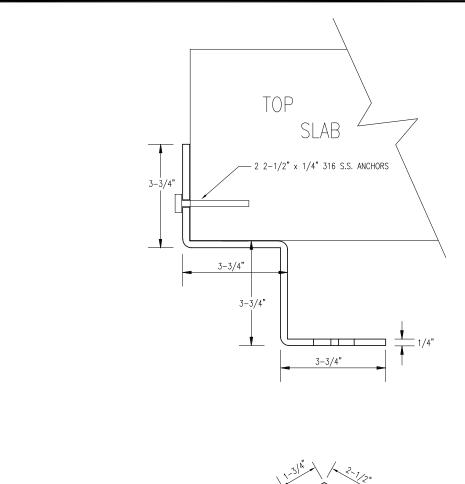

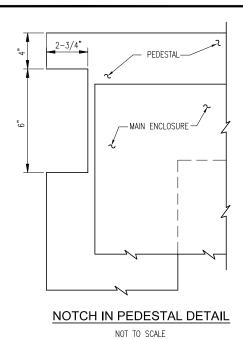

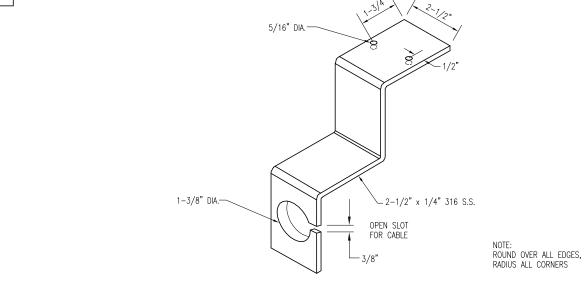NOT TO SCALE

INTERLOCK MOUNTING DETAIL

1-M1

CB-1

NOT TO SCALE

DB10 OR PULSAR MOUNTING BRACKET DETAIL

NOT TO SCALE

SEE NOTES ON SHEET E-15
100% CONSTRUCTION DOCUMENTS -03/24/14

MILLS and ASSOCIATES, INC.

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TELEPHONE: (813) 876-5869



777 S. Harbour Island Blvd, Suite 870 Tampa, FL 33602 813,227,9190 Certificate of Authorization No. 8363 - SEE DETAIL BELOW

	JOB No.	13060					SCALE	
	DESIGNED	DEV						۱ (
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	DATE	03/24/14	No.	DATE	BY	REVISION DESCRIPTION	NTS	HAD

 C^{1TY} of $T_{AMP_{\mathcal{A}}}$

LINEBAUGH PUMPING STATION
REHABILITATION
ELECTRICAL DETAILS

	SHEET NUMBER
	E-14
DENNIS VANN P.F. No. 57620	FILE: 1713060

NOTES

- 1. THWN CONDUCTORS (3 #8 AWG + 1 #10 AWG GND. CU FOR EACH MOTOR) SHALL EXTEND FROM THE CONTROL PANEL BELOW THE SEAL—OFF A MINIMUM OF 18" AND SHALL BE SEALED IN THE SEAL—OFF SHOWN. THE SHOWN SEAL—OFFS SHALL BE ALUMINUM BODY, CROUSE—HINDS, OR EQUIVALENT. WHEN INSTALLING THE PUMPS, THE MOTOR CONDUCTORS SHALL BE SPLICED USING SPLIT BOLTS. FOR INSULATION USE MATERIALS THAT ARE RECOMMENDED BY MANUFACTURER TO EQUAL INSULATION ON CONDUCTORS. FOLLOW THE SAME PROCEDURE FOR THE LEAKAGE AND THERMAL SENSOR CONDUCTORS.
- CONCRETE PAD SHALL BE CONSTRUCTED OF CLASS B CONCRETE REINFORCED WITH 4x4-W6x6 WWF AND SHALL HAVE A MINIMUM THICKNESS OF 6".
- 3. DIMENSIONS, ITEMS OR ELEVATIONS MARKED "*" TO BE DETERMINED AFTER EQUIPMENT SELECTION.
- 4. APPROVED GROUND CLAMPS SHALL BE ATTACHED TO TWO APPROVED GROUNDING RODS (MINIMUM SPACING 6'-0") AND THE METALLIC WATER LINE. GROUNDING CONDUCTOR SHALL BE AWG # 4 MIN. BARE STRANDED COPPER.
- 5. THE CONTRACTOR SHALL PROVIDE AND INSTALL A 316 S.S. MOUNTING BRACKET TO SUPPORT THE DB10 TRANSMITTER. THE BRACKET SHALL BE INSTALLED IN THE WET WELL, CITY INSTRUMENTATION PERSONNEL WILL ASSIST THE CONTRACTOR WITH SPECIFYING THE TRANSDUCER MOUNTING LOCATION AND CALIBRATION. REFER TO DB10 DETAIL ON SHEET E-14.
- 6. METER SOCKET SUPPLIED, AND INSTALLED BY CONTRACTOR, ALSO SEE NOTE #16. THE SOCKET EDGES ARE TO BE ALIGNED WITH THE BACK AND TOP EDGE OF THE MAIN ENCLOSURE.
- CITY APPROVED TYPE 1 SURGE PROTECTIVE DEVICE (LIGHTNING ARRESTER) TO BE INSTALLED BY CONTRACTOR ON LOAD SIDE OF METER SOCKET.
- 8. ELBOWS TO BE LONG BUSHED AND THE HORIZONTAL PVC CONDUIT SHALL EXTEND TO A TECO HAND—HOLE AT THE BASE OF THE POWER POLE. PROVIDE 24" MINIMUM COVER. COORDINATE THIS WORK WITH TECO.
- RESERVED.
- 10. WATER SERVICE RISER TO BE LOCATED ON THE SIDE OF PANEL OPPOSITE TO THE TECO METER BOX.
- 11. ALUMINUM CONDUIT SURFACE THAT IS IN CONTACT WITH SOIL OR CONCRETE SHALL BE COATED WITH TWO COATS ASPHALT VARNISH (FED. SPEC. TT-V-51) EXTENDING 4" BEYOND FINAL CONTACT POINT.
- 12. FRONT OF OPEN SPACE TO BE COVERED BY A LOUVERED ALUM. METAL SHEET (MIN. THICKNESS 0.125) AND FASTENED WITH MIN. OF FOUR 3/8" STAINLESS STEEL BOLTS ANCHORED IN THE CONCRETE. THE LOUVERED PANEL SHALL BE PROPERLY BONDED TO EXISTING METALLIC WATER PIPE USING MINIMUM #8 THWN CU. EXTRA FLEXIBLE GROUNDING CONDUCTOR.
- 13. SEALING FITTING SHALL BE SIZED FOR CONDUCTORS. ENSURE THAT SEALING FITTING CONNECTION TO MAIN ENCLOSURE IS GAS TIGHT. USE HIGH QUALITY SEALING LOCKNUTS OR WATERTIGHT HUBS WITH A SUPPLEMENTAL BARRIER (IF NECESSARY) TO EXCLUDE GASES.
- 14. ENSURE THAT SEALING FITTING CONNECTION TO MAIN ENCLOSURE IS GAS TIGHT, USE HIGH QUALITY SEALING LOCKNUTS OR WATER TIGHT HUBS WITH SUPPLEMENTAL BARRIER (IF NECESSARY) TO EXCLUDE GASES.
- 15. REINFORCEMENT SHALL BE AT LEAST 3" FROM EDGE OF PEDESTAL.
- 16. TECO PREFERS STRAIGHT UNDERGROUND SERVICE CONNECTION TO THE METER BOX. TO AVOID ANY CONFIGURATION CHANGES, THE ENCLOSURE HOLES FOR THE METER BOX AND EMERGENCY CONNECTOR SHALL BE CUT AFTER THE TECO ROUTING IS VERIFIED AT THE TIME OF INSTALLATION. THE LENGTH OF CONDUCTORS FROM TECO AND EMERGENCY SERVICES WILL DEPEND ON THE SELECTED CONFIGURATION.
- 17. STAINLESS STEEL HANGERS TO SUPPORT THE EXCESS LENGTH OF MOTOR CABLES SHALL BE INSTALLED IN THE WET WELL. THESE HANGERS SHALL BE LOCATED IN A SEPARATE AREA FROM THE HANGERS SUPPORTING THE PUMP CHAINS.
- 18. TOP OF ENCLOSURE SHALL BE A MAXIMUM OF 66" ABOVE FINAL GRADE.
- 19. EXTEND CONCRETE PAD SUCH THAT IT IS FLUSH WITH PUMPING STATION TOP SLAB.
- 20. PROVIDE AND INSTALL 1" PVC CONDUIT FOR FUTURE ODOR CONTROL EQUIPMENT AS SHOWN. EXTEND CONDUIT TO EDGE OF PAVEMENT, TURN UP, AND CAP ABOVE GRADE.
- 21. FOR ANY CONDUIT NOT EXTENDING TO THE WET WELL, USE COATED RIGID ALUMINUM FOR RISER, MYERS HUB AND UNY TYPE EXPLOSION PROOF UNION.
- 22. PROVIDE AND INSTALL A PRESTRESSED CONCRETE POLE WITH LED OUTDOOR SECURITY FIXTURE AND LIGHT SWITCH.

100% CONSTRUCTION DOCUMENTS -03/24/14

MILLS and ASSOCIATES, INC.

CONSULTING ENGINEERS & LAND SURVEYORS
3242 HENDERSON BOULEVARD - SUITE 300
TAMPA, FLORIDA 33609-3056
TELEPHONE: (813) 876-5869



777 S. Harbour Island Blvd, Sulte 870 Tampa, FL 33602 813.227.9190 Certificate of Authorization No. 8363

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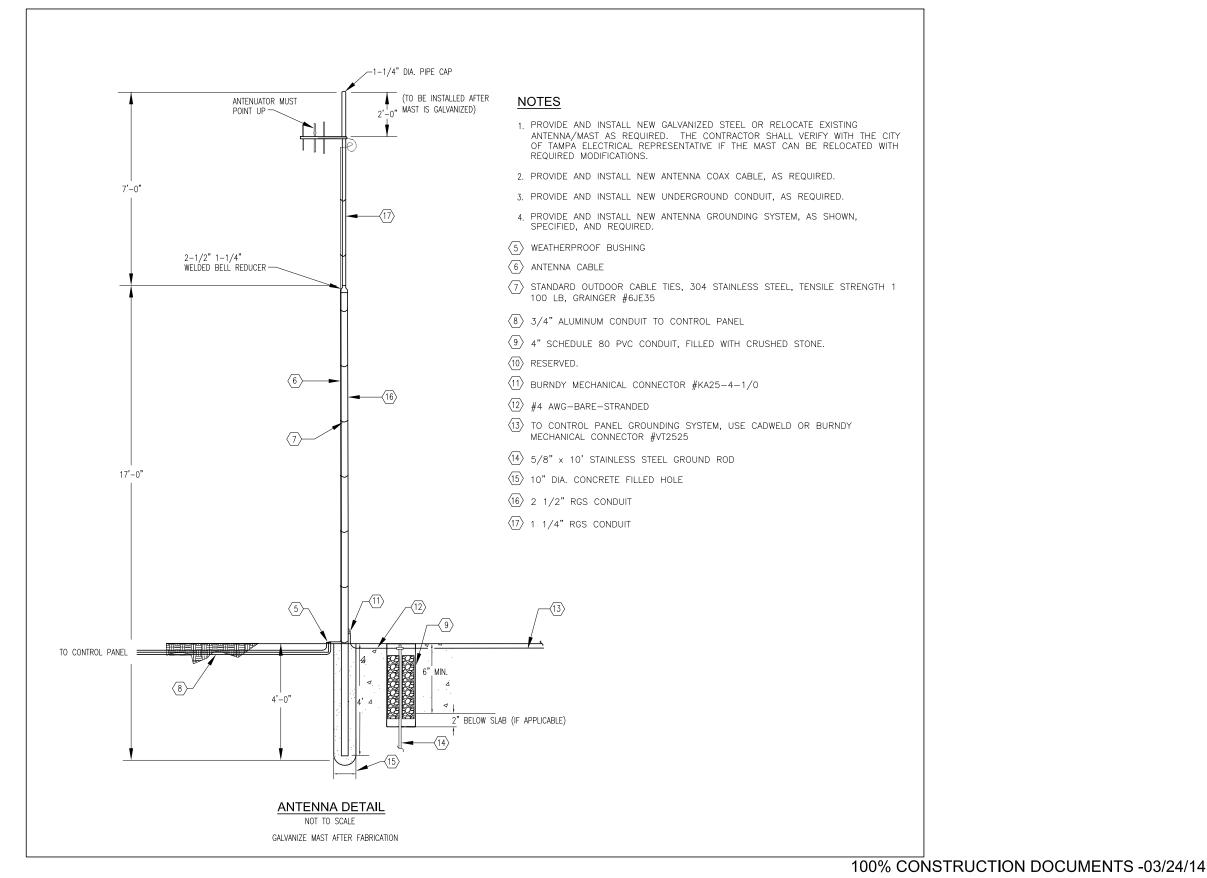
LINEBAUGH PUMPING STATION
REHABILITATION
ELECTRICAL NOTES FOR SHEETS E12 - E14

SHEET NUMBER

E-15

DENNIS VANN P.E. No. 57620

FILE: 1713060



MILLS and ASSOCIATES, INC.

CONSULTING ENGINEERS & LAND SURVEYORS 3242 HENDERSON BOULEVARD — SUITE 300 TAMPA, FLORIDA 33609—3056 TELEPHONE: (813) 876—5869



777 S. Harbour Island Blvd, Suite 870 Tampa, FL 33602 813,227.9190 Certificate of Authorization No. 8363

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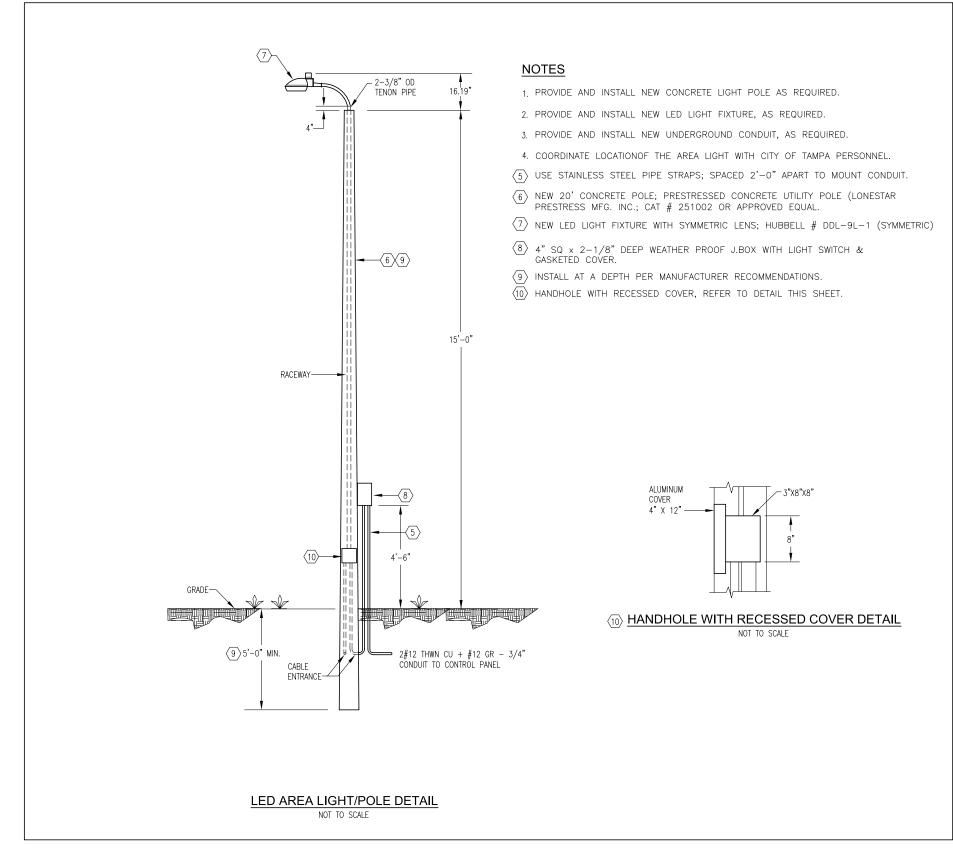
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LINEBAUGH PUMPING STATION
REHABILITATION
ELECTRICAL DETAILS

SHEET NUMBER

E-16

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CONSULTING ENGINEERS & LAND SURVEYORS

3242 HENDERSON BOULEVARD - SUITE 300

TAMPA, FLORIDA 33609-3056

TELEPHONE: (813) 876-5869



777 S. Harbour Island Blvd, Suite 870 Tampa, FL 33602 813.227.9190 Certificate of Authorization No. 8363

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LINEBAUGH PUMPING STATION
REHABILITATION
ELECTRICAL DETAILS

SHEET NUMBER

E-17

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